El Paso Leadership Academy
RFP #2021-003 – Low Voltage Systems Contractor
EXHIBIT H – Project Documents

Project Documents

The following Project Documents consist of only applicable sheets from the 100% Construction Documents dated 12/21/2020 and issued by Root Architects and RAXIS Engineering. Other sheets (enlarged plans, details, elevations, etc.) can be provided upon request and will be uploaded as Addenda.

EL PASO LEADERSHIP ACADEMY

2101 JOE BATTLE BOULEVARD, EL PASO, TEXAS 79938



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AA505 DETAILS

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AA703 EXTERIOR RENDERING

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GRADING SECTIONS

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GRADING DETAILS

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GRADING DETAILS

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AS100 DETAILED SITE DEVELOPMENT PLAN

UTILITY DETAILS

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U-02 UTILITY DETAILS

U-04 UTILITY DETAILS

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LI101 IRRIGATION PLAN

LP501 PLANTING DETAILS

AS101 ENLARGED VIEWS

× AS130 SHELL FF PLAN LVL 1

5 AS131 SHELL FF PLAN LVL 2

AS140 SHELL - ROOF PLAN

AS203 SHELL EXT. ELEVATIONS ≤ AS301 SHELL BLDG. SECTION ய் AS302 SHELL BLDG. SECTION AS401 SHELL - ENL. FLOOR PLANS AS402 SHELL - ENL. FLOOR PLANS

AS403 SHELL - WALL SECTION

AS406 SHELL - STAIRS / ELEV.

AS408 SHELL - STAIR DETAIL AS501 PLAN DETAILS ♀ AS504 SECTION DETAILS

AS407 SHELL - STAIR DETAIL

AS505 SECTION DETAILS

AS602 SPECS SHEET

AS601 SHELL - DR. / WIND. SCHED.

AS404 SHELL - STAIRS AS405 SHELL - STAIRS / ELEV

AS110 SHELL FLOOR PLAN LVL

SHELL FLOOR PLAN LVL 2

AS103 DETAILS

LI501 IRRIGATION DETAILS A

LI502 IRRIGATION DETAILS B

LANDSCAPE

STORM WATER POLLUTION

MECHANICAL

MECHANICAL GENERAL FIRST FLOOR PLAN MECHANICAL PLAN SECOND FLOOR MECHANICAL PLAN FIRST FLOOR VRF PIPING PLAN VRF DIAGRAM MECHANICAL ROOF PLAN MECHANICAL SCHEDULES MECHANICAL SCHEDULES MECHANICAL DETAILS

ELECTRICAL SITE PLAN

LIGHTING PLAN LEVEL 2

HVAC POWER PLAN LEVEL

HVAC POWER PLAN LEVEL 2

LIGHTING PLAN LEVEL

POWER PLAN LEVEL 1

POWER PLAN LEVEL 2

ELECTRICAL DETAILS

ELECTRICAL DETAILS

COMPLIANCE REPORT

PLUMBING GENERAL NOTES PLUMBING DOMESTIC WATER PLAN - FIRST FLOOR PLUMBING DOMESTIC WATER PLAN - SECOND FLOOR ENLARGED DOMESTIC WATER PLAN - FIRST FLOOR ENLARGED DOMESTIC WATER PLAN - SECOND FLOOR PLUMBING SEWER AND VENT - FIRST FLOOR PLUMBING SEWER AND VENT - SECOND FLOOR ENLARGED PLUMBING SEWER AND VENT -FIRST FLOOR ENLARGED PLUMBING SEWER AND VENT SECOND FLOOR FIRST FLOOR CONDENSATE DRAIN PLUMBING DETAILS P702 PLUMBING DETAILS


CODE

CITY OF EL PASO

APPLICABLE CODES 2015 INTERNATIONAL BUILDING CODE (IBC) WITH LOCAL AMENDMENTS 2015 INTERNATIONAL RESIDENTIAL CODE (IRC) WITH LOCAL AMENDMENTS 2015 INTERNATIONAL MECHANICAL CODE (IMC) WITH LOCAL AMENDMENTS 2015 INTERNATIONAL PLUMBING CODE (IPC) AND THE 2009 INTERNATIONAL FUEL GAS CODE (IFGC) WITH

2015 NATIONAL ELECTRIC CODE (NEC) WITH LOCAL AMENDMENTS 2015 INTERNATIONAL ENERGY CONSERVATION CODE (IECC) WITH LOCAL AMENDMENTS UNIFIED DEVELOPMENT CODE (UDC) CITY CODE CHAPTER 10 (ELECTRICAL)

VICINITY MAP

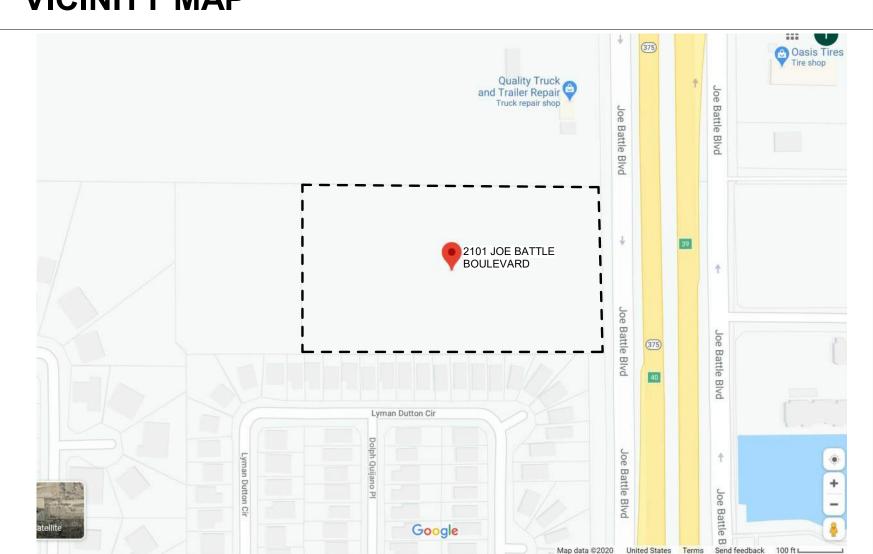

DRO IECT INFORMATION

PROJECT INFORMATION	l
HE DRAWING SET CONTAINED WITHIN REPRESENTS A COMPLETE SET OF CONSTRUCTION DCUMENTS, APPROVED BY THE GOVERNING MUNICIPALITY. UNDER NO CIRCUMSTANCES WILL WORK AND CONTRACTOR SEPARATE DRAWINGS THE ARCHITECT WILL NOT BE HELD LIABLE FOR	1. 2.
NY CHANGES OR DEVIATIONS FROM THE DRAWING SET WITHOUT THE EXPLICIT WRITTEN CONSENT ROM THE ARCHITECT. ALL CHANGES MUST BE DONE IN WRITING. DRAWING SET NOT TO BE	3.
SASSEMBLED AT ANY TIME. WNER NAME: OWNER SIGNATURE:	4.
ATE:	5.
DNTRACTOR NAME: CONTRACTOR	6.
IGNATURE DATE:	0.
	7.
LI SUB-CONTRACTORS SHALL RECEIVE A COMPLETE SET OF CONSTRUCTION DOCUMENTS AND PECIFICATIONS AND SHALL BE RESPONSIBLE FOR THEIR COMPLETE SCOPE OF WORK REGARDLESS	8.
F WHERE IN THE DOCUMENT SET THE DESCRIPTION OF WORK APPEARS. ANY WORK PERFORMED ILL MEET ALL CURRENT CODE REQUIREMENTS, NO EXCEPTIONS WILL BE ALLOWED.	9.
L SUBCONTRACTORS WILL RECEIVE A FULL SET OF DRAWINGS FOR VERIFICATION AND	10.
DORDINATION. CONTRACTOR WILL IMMEDIATELY NOTIFY ARCHITECT AND OWNER OF ANY AND ALL RAWING DISCREPANCIES AND FILED VERIFICATION ISSUES.	11.
L ENTRANCE DOORS MIN. 36" WIDE AND ON AN ACCESSIBLE ROUTE.	10
/FRY ELECTRICAL PANEL LIGHT SWITCH AND THERMOSTAT SHALL BE MOLINTED NO HIGHER THAN	12.

EVERY ELECTRICAL PANEL, LIGHT, SWITCH, AND THERMOSTAT SHALL BE MOUNTED NO HIGHER THAN 48" A.F.F. EVERY ELECTRICAL OUTLET OR OTHER RECEPTACLE SHALL BE MOUNTED AT LEAST 15" A.F.F. EXCEPT IN KITCHEN AND BATHROOMS OR UNLESS OTHERWISE NOTED. COORD. LOCATION W/ ARCHITECT PRIOR TO INSTALLATION. EXTERIOR ELECTRICAL PANEL MUST BE MOUNTED BETWEEN 18" AND 42" ABOVE FINISHED GRADE

AND MUST BE SERVICED BY AN ACCESSIBLE ROUTE, COORD. LOCATION WITH OWNER. ALL HARDWARE TO OPEN AND CLOSE DOORS AND OPERATE PLUMBING FIXTURES SHALL HAVE LEVER HANDLES, WITH THE EXCEPTION OF PANIC HARDWARE, REF. HARDWARE SPECS. ALL DIMENSIONS TO EDGE OF STUD WALLS U.N.O.; HOLD ALL C.L. AS NOTED.

CONTRACTOR SHALL FIELD VERIFY ALL CONDITIONS/DIMENSION AND REPORT ANY

CONTRACTOR TO VERIFY FINISH FLOOR ELEVATION WITH ARCHITECTURAL FINISH FLOOR HTS., ALONG WITH STRUCTURAL FOUNDATION/GRADING PLANS. CONTRACTOR WILL PROVIDE FOR POSITIVE

DIMENSIONS AT EXTERIOR DOOR & WINDOWS SHOW NOMINAL OPENINGS. CONTRACTOR SHALL VERIFY ROUGH OPENINGS W/ WINDOW/DOOR MFCTR. ALL WORK SHALL COMPLY WITH ALL APPLICABLE CODES. CONTRACTOR TO NOTIFY ARCHITECT

IMMEDIATELY OF ANY CONDITIONS THAT APPLY. CONTRACTORS TO VERIFY AND COORDINATE ALL EQUIPMENT, MATERIALS, FINISHES, APPLIANCES, FIXTURES, ETC. TO ENSURE PROPER FIT AND FINISH. ANY ITEMS SPECIFIED TO ACHIEVE FINISHED PRODUCT SHALL BE INCLUDED IN BID. CONTRACTORS SHALL INFORM OWNER OF ALL ALLOWANCES, WHETHER SCHEDULED OR NOT, TO ENSURE ALLOWANCES ARE REALISTICALLY BUDGETED TO

CONTRACTORS TO VERIFY LOCATION OF ALL EXISTING UTILITIES PRIOR TO ANY CONSTRUCTION AND COORDINATE WITH THE UTILITY COMPANY/ MUNICIPALITY FOR CONNECTION REQUIREMENTS, AND INCLUDE ASSOCIATED COSTS FOR THE CONNECTIONS AND/OR RELOCATIONS IN BID. PROVIDE POSITIVE DRAINAGE AWAY FROM ALL STRUCTURES AND ADJACENT PROPERTY WITH DRAINAGE FLOW TO MATCH EXISTING PATTERNS WITHOUT CREATING PUDDLES OR EROSION PROBLEMS. CONTRACTOR TO INCLUDE ANY REQUIRED CONSTRUCTION PHASE EROSION CONTROL

PROVIDE & MAINTAIN A CLEAN PROJECT SITE PROPERLY DISPOSING OF ALL TRASH & DEBRIS TO KEEP FROM BLOWING INTO NEIGHBORING PROPERTY AREAS. STORE ALL MATERIALS PROPERLY TO KEEP DRY AND PROTECT FROM DAMAGE. PROTECT WORK FROM DAMAGE BY WEATHER & OTHER TRADES, AND SECURE/ PROJECT SITE AT

ALL MECHANICAL/ELECTRICAL/PLUMBING (MP) SYSTEMS SHALL BE DESIGNED AND INSTALLED PER CODE. THE CONTRACTOR SHALL COORDINATÉ THESE SYSTEMS WITH THE STRUCTURAL AND ARCHITECTURAL DESIGN. THE ARCHITECT AND OWNER SHALL BE NOTIFIED OF ANY CONFLICTS. ALL CHANGES TO ANY SYSTEM MUST BE APPROVED BY THE ARCHITECT AND OWNER PRIOR TO ANY PURCHASING OR CONSTRUCTION.

BUILDING AND TENANT SIGNAGE BY OTHERS. CONTRACTOR TO COORDINATE WITH OWNER ALL STRUCTURAL AND ELECTRICAL REQUIREMENTS FOR ANY AND ALL EXTERIOR SIGNAGE. ANY PATIO/COURTYARD LANDSCAPING IS INCLUDED IN SCOPE. CONTRACTOR WILL

COORDINATE WITH OWNER COST AND SCOPE PRIOR TO SUBMITTING A FINAL BID. CONTRACTOR WILL COORDINATE BUILDING SECURITY, AND BUILDING ALARM CONNECTIONS WITH

ARCHITECTS AND OWNER PRIOR TO THE INSTILLATION OF FINISHES. CONTRACTOR WILL COORDINATE DATA/INTERNET LOCATION AND DISTRIBUTION WITH OWNER AND ARCHITECT IN FIELD PRIOR TO ANY CONSTRUCTION. VERIFY LOCATIONS OF GUTTERS & DOWNSPOUTS WITH OWNER. ALL DOWNSPOUTS TO SPILL ONTO

CONCRETE SPLASH BLOCKS, OR RUN IN CULVERTS BELOW SIDEWALKS. THE TERM "AS REQUIRED" HEREIN MEANS AS NEEDED TO ACHIEVE A QUALITY FINISHED PRODUCT. THE TERM "CONTRACTOR" HEREIN REFERS TO ANY AND ALL CONTRACTORS AND/OR SUBCONTRACTORS THAT PERFORM WORK ON THE PROJECT

△ COM*check* Software Version 4.1.4.3

Envelope Compliance Certificate Location: Climate Zone: Project Type: El Paso, Texas Construction Site: 2101 JOE BATTLE EL PASO, TX 79938 Additional Efficiency Package(s) Reduced interior lighting power. Requirements are implicitly enforced within interior lighting allowance calculations.

Window 1: Metal Frame with Thermal Break:Fixed, Perf. Specs.: Product ID kawneer storefront, SHGC 0.10, PF 1.00, [Bldg. Use 1 - School/University] (b) Door 1: Uninsulated Single-Layer Metal, Swinging, [Bldg. Use 1 -Door 2: Glass (y 50% glazing):Metal Frame, Entrance Door, Perf. Specs.: Product ID kawneer system, SHGC 0.10, PF 1.00, [Bldg. Use 1 - School/University] (b) (a) Budget U-factors are used for software baseline calculations ONLY, and are not code requirements.

b) Fenestration product performance must be certified in accordance with NFRC and requires supporting documentation.
c) High albedo roof requirement options: 1) 3-year aged solar reflectance >= 0.55 thermal emittance >= 0.75, 2) 3-year aged solar reflectance index >= 64.0, 3) Initial year aged solar reflectance >= 0.70 thermal emittance >= 0.75, 4) Initial year aged solar reflectance index >= 82.0.

root

311 MONTANA * EL PASO TX, 79902

915.307.0574 * www.arcroot.com

VIEWTECH

4205 BELTWAY DRIVE * ADDISON, TX 75001

972.661.8187

1712 TEXAS * EL PASO TX, 79901

915.726.9521

Data filename: Z:\Projects\Educational\EPLA - CANTERA\12-PERMIT PACKAGE\EPLA - East.cck

TEAM

915.833.2400

DATA

GEOGRAPHIC IDENTIFICATION NUMBER: V897999109A0700 ADDRESS: 2101 JOE BATTLE BLVD EL PASO, TX 79938 LEGAL DESCRIPTION: 109-A VISTA HILLS #46 LOT 7 (267937.56 SQ FT)

SCOPE OF WORK: NEW CONSTRUCTION OCCUPANCY/USE: E

> TOTAL # OF STRUCTURE PROPOSED: 1 VALUATION OF PROJECT:

NEW T.I SQ. FOOTAGE (Addition): N/A GROSS SQ. FOOTAGE (Combined): 70,941 SF TOTAL

AREA SQ. FOOTAGE (ITEMIZED):

14. ALLOWABLE AREA: BUILDING HEIGHT: 50' - 0"

TOTAL NUMBER OF STORIES IN STRUCTURE: 2 CONSTRUCTION TYPE: 2-B

ASSEMBLY SPACE:

STORAGE/B.O.H.:

CLASSROOOM: RR/CIRCULATION/UNOCCUPIED/: 33,549

PARKING REQUIRED: SPACES REQUIRED: SPACES PROVIDED:

PLUMBING FIXTURE COUNT: MEN'S + WOMEN'S W.C.: MEN'S + WOMEN'S LAV: DRINKING FOUNTAIN: SEE SHEET AA004 - CODE REVIEW

DISTANCE FROM BUILDING TO THE NEAREST FIRE HYDRANTS FIRE HYDRANT #: <u>8378</u> - DISTANCE - <u><400'-0</u> FIRE HYDRANT #: <u>7966</u> - DISTANCE - <u><200'-0</u>"

INCHES OF EGRESS REQUIRED: 36 "

EXIT ACCESS TRAVEL DISTANCE: <75'-0" REQ'D RATED WALLS DESIGNATED:

YES<u>X</u> NO_ TABC REQUIRED: YES__ NO_X FOOD SERVICE: YES__ NO_X SWIMMING POOL: YES__ NO X SPRINKLERED STRUCTURE: YES X NO_ YESX NO_ STANDPIPE: (NOT REQUIRED IFC 905) YESX NO_ DEMOLITION REQUIRED:

STRUCTURAL DESIGN VERIFIED: YES<u>X</u> NO_ GRADING PERMIT REQUIRED: PAVEMENT CUTS: FLOOD ZONE VERIFIED:

37. TABS2021004488

Envelope Compliance Statement

PROJECT CHECKLIST


Project Title: EL PASO LEADERSHIP ACADEMY

UTILITY/LANDSCAPE/CIVIL/+ARCH. DRAWINGS, TO INCLUDE SITE UTILITY. CURB. BUILDING FOOTPRINTS. STAIR

/RAMP + DRIVEWAY LOCATIONS.

THE FOLLOWING IS A LIST OF KEY CONSTRUCTION MILESTONES THAT MUST BE COORDINATED WITH ARCHITECT, OWNER, AND CONTRACTOR PRIOR TO THE COMMENCEMENT OF EACH ITEM: OWNER WILL NOT HOLD ARCHITECT RESPONSIBLE FOR ANY AND ALL CHANGES TO DRAWINGS AND/OR DEVIATIONS FROM THE DRAWINGS DURING CONSTRUCTION OR WITHOUT THE WRITTEN CONSENT OF THE ARCHITECT.

OWNER'S NAME:	OWNER'S SIGNATURE	i:	DATE:	
CONSTRUCTION MILESTONE	ARCHITECT	OWNER	CONTRACTOR	
POURING OF ANY CONCRETE CURB, FOOTING, OR SLAB. VERIFY F.F. HTS.				
ROUGH IN LOCATION FOR ALL UNDERGROUND MEP SERVICES + SYSTEMS.				
ALL UNDERSLAB PLUMBING + ELECTRICAL FIXTURE LOCATIONS TO INCLUDE FLOOR DRAINS, SINKS, + RECEPTACLES.				
FRAMING, TO INCLUDE DOOR + WINDOW LOCATIONS.				
STRUCTURAL COLUMN LOCATIONS AND ERECTION.				
MASONRY PATTERN + ERECTION TO INCLUDE BRICK AND CMU LAYOUT AND COURSING.				
EXTERIOR FINISH WALL + CURTAIN WALL MOCK UP				
INTERIOR ELECTRICAL LOCATIONS (JBOX LOCATION PRIOR TO RUNNING OF CONDUIT) TO INCLUDE SWITCH, OUTLET, + RECEPTACLES.				
ROOF AND ROOF SYSTEMS TO INCLUDE MECHANICAL EQUIPMENT + VENT STACK/EXHAUST LOCATIONS				
VERIFY ALL SITE CONDITIONS AS PER				

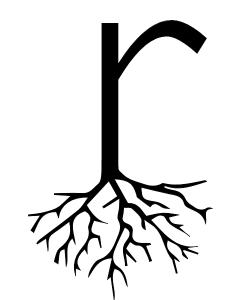

311 MONTANA - STE A2-100 EL PASO, TX 79902



GENERAL NOTES

DOCUMENTS PROVIDED IN THIS PACKAGE HAVE BEEN PRODUCED BY ROOT ARCHITECTS AND CAN NOT BE MODIFIED. ANY FORM OF MODIFICATION OR CHANGE TO ANY PORTION OF THIS SET, BOTH TO THE DRAWINGS AND DURING CONSTRUCTION, WITHOUT WRITTEN APPROVAL FROM THE ARCHITECT IS STRICTLY FORBIDDEN. IF ANY CHANGES OR MODIFICATIONS ARE MADE WITHOUT THE ARCHITECT OF RECORD'S WRITTEN APPROVAL AND APPROVAL FROM ANY GOVERNING AGENCY THAT MAY BE REQUIRED, THE ARCHITECT WILL NOT BE HELD RESPONSIBLE OR LIABLE FOR DAMAGES OR DELAYS IN

. OWNER AND CONTRACTOR ACKNOWLEDGE THAT THE

• OWNER SIGNATURE + DATE:

GENERAL CONTRACTOR SIGNITURE + DATE:

DOCUMENTS PROVIDED IN THIS PACKAGE ARE REPRESENTATIVE OF A COMPLETE DRAWING SET. UNDER NO CIRCUMSTANCES WILL OWNER AND CONTRACTOR SEPARATE DRAWINGS. . ALL SUB-CONTRACTORS SHALL RECEIVE A COMPLETE SET OF CONSTRUCTION DOCUMENTS AND SPECIFICATIONS AND SHALL BE RESPONSIBLE FOR THEIR COMPLETE SCOPE OF WORK REGARDLESS OF WHERE IN THE DOCUMENT SET THE DESCRIPTION OF WORK APPEARS ANY WORK PERFORMED WILL MEET ALL CURRENT CODE REQUIREMENTS, NO EXCEPTIONS WILL BE ALLOWED. 4. THE CONTRACTOR SHALL REQUIRE ALL INSTALLERS TO VERIFY THAT SUBSTRATES, STARTING POINTS ETC. CONFORM WITH THE INTENT OF THE CONTRACT DOCUMENTS. INSTALLERS SHALL REPORT, IN WRITING, ANY DISCREPANCIES WHICH AFFECT THE WORK ALLOWING SUFFICIENT TIME TO ENABLE THE GENERAL CONTRACTOR TO DETERMINE AND EXECUTE CORRECTIVE MEASURES REQUIRED, BUT NO LATER THAN ONE WEEK PRIOR TO THE SCHEDULED START OF THE WORK. 5. DIMENSIONS ARE TO FACE OF STUDS UNLESS NOTED 6. REFER TO BUILDING SECTIONS AND ELEVATIONS FOR ALL PLATE HEIGHTS. 7. REFER TO WINDOW SCHEDULE FOR HEAD AND SILL HEIGHTS. WINDOW SELECTION AS PER OWNER. SELECTED WINDOWS MUST MEET ENERGY CODE REQUIREMENTS. REFER TO WINDOW SCHEDULE FOR SIZES. 8. REFER TO DOOR SCHEDULE FOR HEAD HEIGHTS. 9. ALL EXTERIOR ELECT. OUTLETS AND OUTLETS LOCATED WITHIN 6'-0" OF KITCHEN SINK, AND BATH VANITIES TO BE GROUND FAULT CIRCUIT INTERRUPTER 10. COORDINATE AC/FURNACE AND WATER HEATER LOCATIONS IN FIELD WITH OWNER AND ARCHITECT PRIOR 11. ALL VENTS, EXHAUST, FANS AND APPLIANCES THAT REQUIRE VENTING TO BE VENTED TO OUTSIDE IN

ACCORDANCE WITH ALL APPLICABLE CODES. 12. SMOKE ALARMS SHALL BE HARD WIRED IN SERIES WITH BATTERY BACKUP POWER IN ACCORDANCE WITH APPLICABLE CODE. 13. VERIFY OUTLET/SWITCH LOCATIONS IN FIELD WITH OWNER AND ARCHITECT. 14. TREATED SOLE PLATE WITH ½ BOLT @4' O.C., BOLT MUST EXTEND AT LEAST 7" INTO CONC. ALL SILL PLATE LUMBER AND ANY LUMBER IN CONTACT WITH CONCRETE OR CMU BLOCKING TO BE MOISTURE TREATED. 15. ALL INTERIOR WALLS TO BE CONSTRUCTED OUT OF 3-5/8" MTL STUD @ 16" O.C. U.N.O. WALLS TO RECIEVE SOUND INSULATION AND 4" METAL COVE BASE U.N.O. 16. ALL EXTERIOR WALLS TO BE CONSTRUCTED OUT OF 6" METAL STUD @16" O.C. WITH BATT OR SPRAY FOAM INSUI ATION, U.N.O. 17. REFER TO FINISH PLAN FOR ALL FINISH SCHEDULES.18. ENSURE EGRESS REQUIREMENTS ARE MET PER 19. COORDINATE HOSE BIB LOCATIONS IN FIELD W/ OWNER AND ARCHITECT. 20. CONTRACTOR TO PROVIDE MOCK UP FOR APPROVAL OF ALL EXTERIOR FINISH MATERIALS AND FENESTRATION 21. CONTRACTOR TO FIELD VERIFY ALL EXISTING UNDERGROUND UTILITES PRIOR TO CONSTRUCTION.

EPLA - CANTERA

2101 JOE BATTI EL PASO TX, 79	
DATE	12.21.2
REV	/ISIONS
-	


SHEET TITLE **COVER SHEET**

SHEET NUMBER

2 CODE REVIEW - AREA PLAN LVL 2
1/16" = 1'-0"



CODE REVIEW - AREA PLAN LVL 1 1 1/16" = 1'-0"

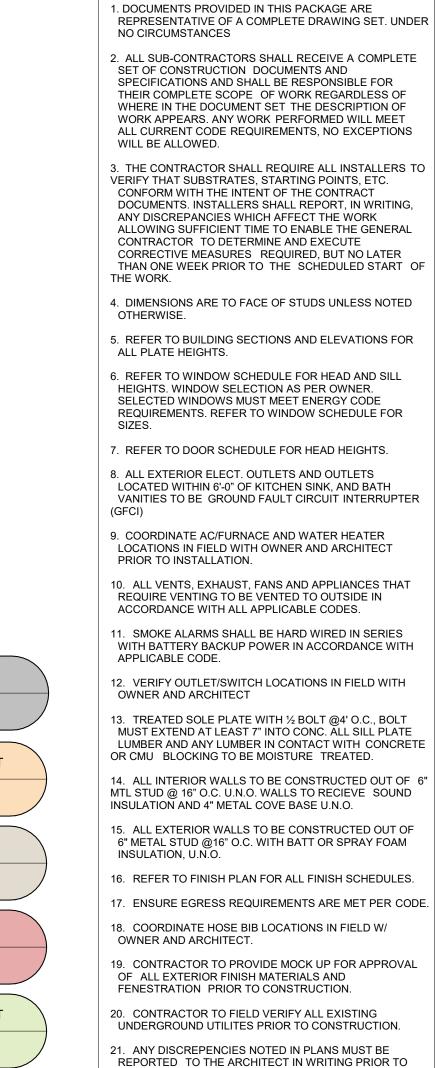

ARCHITECTS (915) 307-0574

311 MONTÁNA - STE A2-100 EL PASO, TX 79902

GENERAL NOTES

OCCUPANCY CALCULATIONS TOTAL OCCUPANTS: 1,696 USE: ASSEMBLY OLF = SF/15 NET AREA: 7,696 SF LOAD: 513 USE: STORAGE* OLF = SF/300 AREA: 2,084 SF LOAD: 7 USE: KITCHEN OLF = SF/200 AREA: 916 SF LOAD: 62 USE: CLASSROOM OLF = SF/20 NET AREA: 20,427 SF LOAD: 1,022 USE: LIBRARY OLF = SF/50 AREA: 2,477 SF LOAD: 50 USE: OFFICE OLF = SF/100 AREA: 4,110 SF LOAD: 42 USE: RESTROOMS AREA: 1,825 SF UNOCCUPIED SPACE AREA: 31,724 SF *SORAGE - EQUIBALENT TO ACCESSORY STORAGE AREA, MECHANICAL EQUIPMENT ROOM AS SHOWN ON TABLE 1004.1.2 IBC 2015 OCCUPANCY LOAD FACTOR BY USE 300 SF 1119 SF 3.731024 2068 SF 6.353929 ASSROOM 20 SF | 13296 SF | 664.789029 LOAD LOAD LOAD FACTOR Area CALC FACOTR 12681 SF 604.557451 25977 SF 1269.34648

* MINIMUM NUMBER OF REQUIRED PLUMBING

FIXTURE SCHEDULE

OILET - FLOOR MOUNTED

TOILET - FLOOR MOUNTED

IRINAL - WALL MOUNTED

TOILET - FLOOR MOUNTED

TOILET - FLOOR MOUNTED

ANITY SINK - SQUARE JRINAL - WALL MOUNTED

TOILET - FLOOR MOUNTED

JRINAL - WALL MOUNTED

VANITY SINK - SQUARE

TOTAL PLUMBING FIXTURE

4178 SF 217.125145 949 SF 2.622905

20 SF 13296 SF 664.789029 200 SF 916 SF 4.580539

100 SF 1841 SF 18.406768 0 SF 991 SF 0

300 SF 1119 SF 3.731024 12681 SF 604.557451

100 SF 2477 SF 24.773662 100 SF 2365 SF 23.645193

885 SF

0 SF 13288 SF

1.636861

SCHEDULE

Product Description

OCCUPANCY LOAD FACTOR BY FLOOR

TOILET - FLOOR MOUNTED VANITY SINK - SQUARE

URINAL - WALL MOUNTED

REST ROOM

OFFICE

UNOCCUPIED SPACE

UNOCCUPIED SPACE 0 SF 14567 SF

TOILET - FLOOR MOUNTED 6

VANITY SINK - SQUARE

'ANITY SINK - SQUARE 6

IRINAL - WALL MOUNTED 4

VANITY SINK - SQUARE

'ANITY SINK - SQUARE

Product Description Count

1 PER 100

CLASSIFICATION: EDUCATIONAL - E

MEN'S + WOMEN'S W.C.:

MEN'S + WOMEN'S LAV:

(IBC 2015 - TABLE 2902.2)

DRINKING FOUNTAIN:

FIXTURES

916 SF 4.580539 2477 SF 24.773662 100 SF | 1841 SF | 18.406768 100 SF 2365 SF 23.645193 4205 SF 42.051962 0 SF 991 SF 0 885 SF 1.636861 1876 SF 1.636861 0 SF 14567 SF 0 SF 13288 SF

EPLA - CANTERA

CONSTRUCTION. CONTRACTOR AND ALL SUB CONTRACTORS ARE RESPONSIBLE FOR NOTIFICATION

OF ANY DESCREPENCY, REGARDLESS OF WHERE THEY

MAY APPEAR IN THE CONSTRUCTION DOCUMENT SET.


2101 JOE BATTLE BLVD EL PASO TX, 79938 DATE

12.21.2020 REVISIONS


SHEET TITLE **CODE REVIEW**

SHEET NUMBER


2 LIFE SAFTY PLAN - LVL2 1/16" = 1'-0"

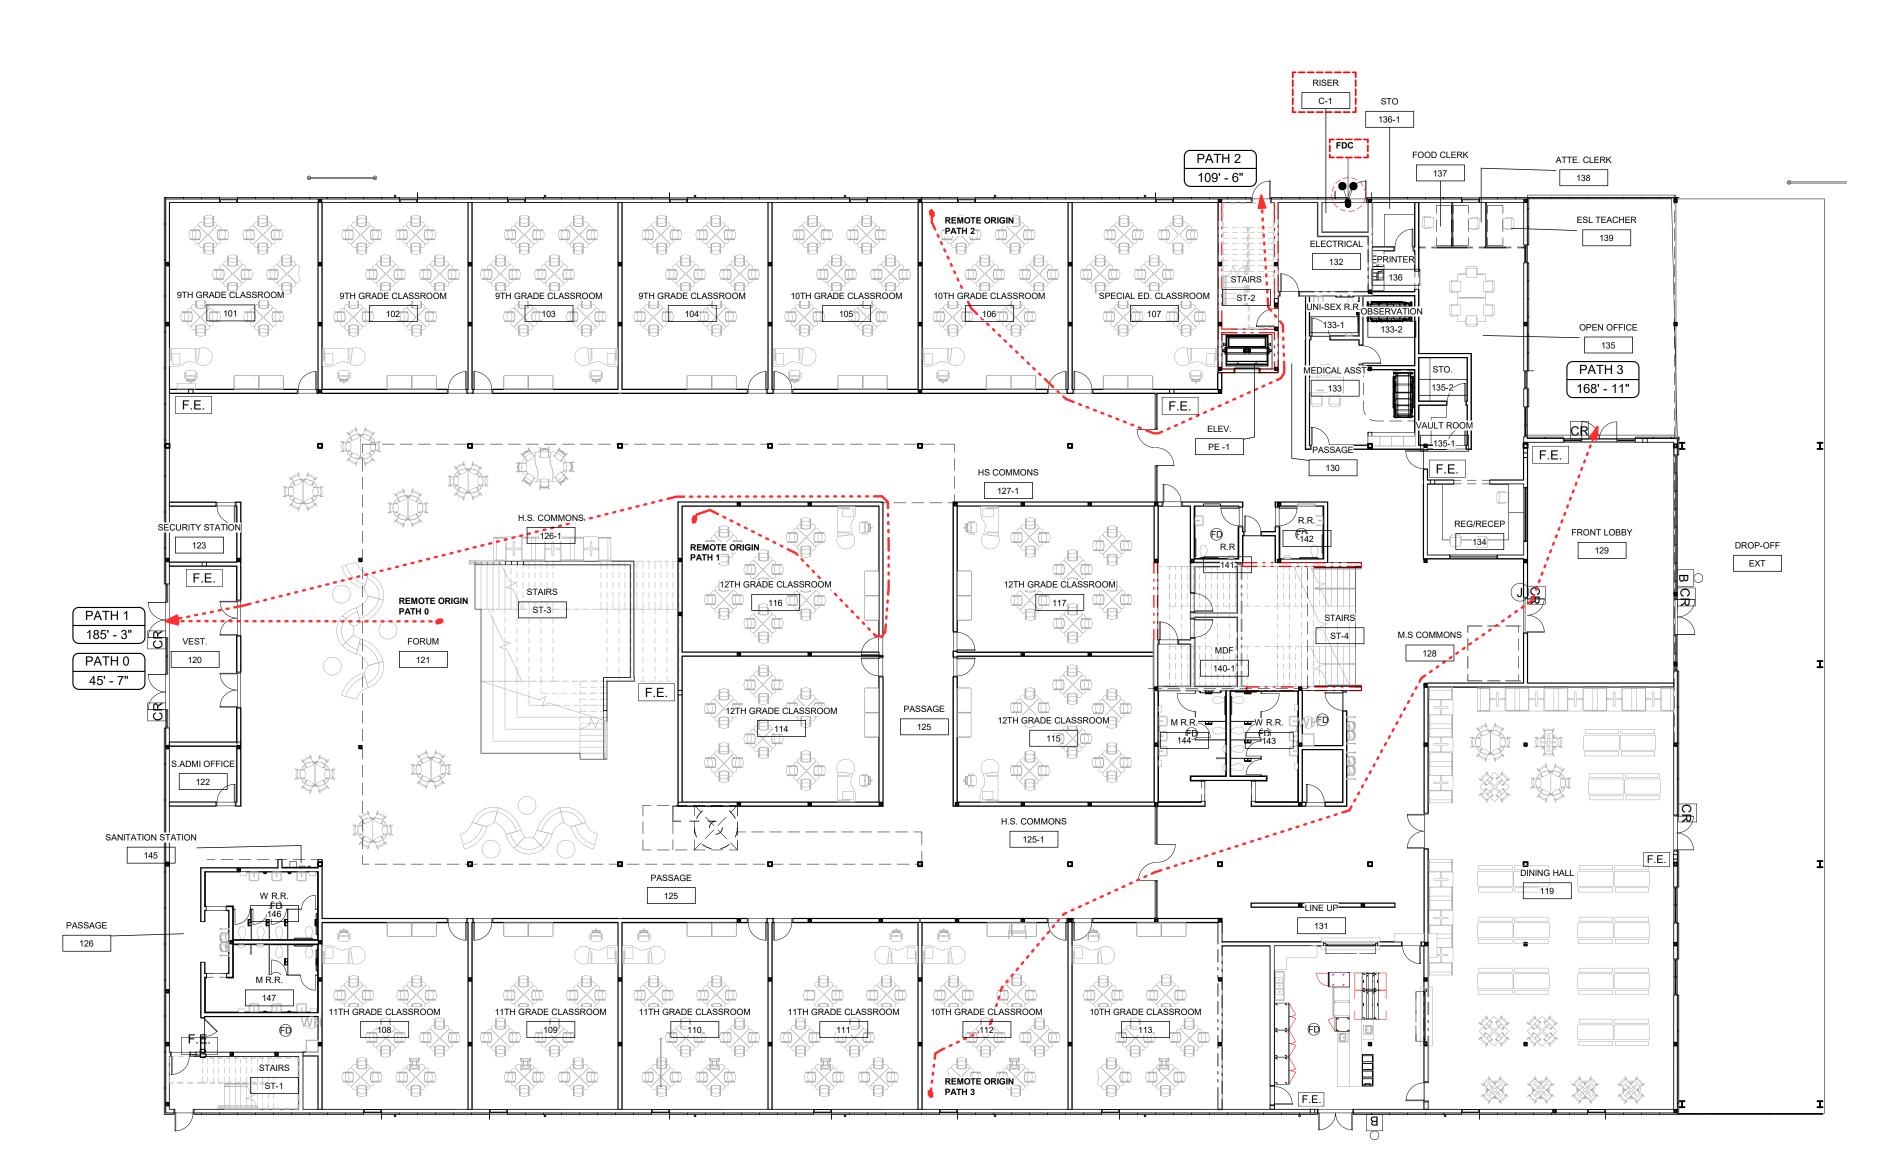

1 LIFE SAFTY PLAN - LVL1 1/16" = 1'-0"

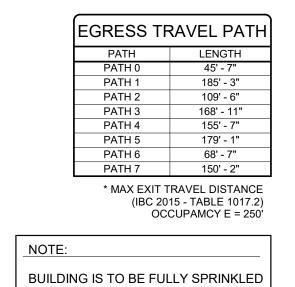

. PATH	EGRESS LEGEND	
NGTH ' - 7"	1 HOUR RATED WALL	_::=:: =
5' - 3" 9' - 6"	2 HOUR RATED WALL	_===
' - 11" 5' - 7" 9' - 1" ' - 7"	RAISER / RAISER ROOM	
)' - 2" ISTANCE	EGRESS	• • • • • • • • • • • • • • • • • • • •
E 1017.2) Y E = 250'	34" EGRESS DOOR	× ₁
	72" EGRESS DOOR	\boxtimes_2
INKLED	FIRE EXTINGUISHER	F.E.

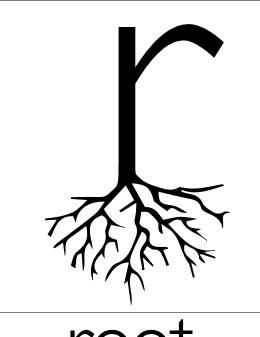





GENERAL NOTES

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3. THE CONTRACTOR SHALL REQUIRE ALL INSTALLERS TO VERIFY THAT SUBSTRATES, STARTING POINTS, ETC. CONFORM WITH THE INTENT OF THE CONTRACT DOCUMENTS. INSTALLERS SHALL REPORT, IN WRITING, ANY DISCREPANCIES WHICH AFFECT THE WORK ALLOWING SUFFICIENT TIME TO ENABLE THE GENERAL CONTRACTOR TO DETERMINE AND EXECUTE CORRECTIVE MEASURES REQUIRED, BUT NO LATER THAN ONE WEEK PRIOR TO THE SCHEDULED START OF

4. DIMENSIONS ARE TO FACE OF STUDS UNLESS NOTED OTHERWISE.

5. REFER TO BUILDING SECTIONS AND ELEVATIONS FOR

ALL PLATE HEIGHTS.

6. REFER TO WINDOW SCHEDULE FOR HEAD AND SILL HEIGHTS. WINDOW SELECTION AS PER OWNER. SELECTED WINDOWS MUST MEET ENERGY CODE REQUIREMENTS. REFER TO WINDOW SCHEDULE FOR SIZES.

 REFER TO DOOR SCHEDULE FOR HEAD HEIGHTS.
 ALL EXTERIOR ELECT. OUTLETS AND OUTLETS LOCATED WITHIN 6'-0" OF KITCHEN SINK, AND BATH VANITIES TO BE GROUND FAULT CIRCUIT INTERRUPTER

COORDINATE AC/FURNACE AND WATER HEATER LOCATIONS IN FIELD WITH OWNER AND ARCHITECT PRIOR TO INSTALLATION.

ALL VENTS, EXHAUST, FANS AND APPLIANCES THAT REQUIRE VENTING TO BE VENTED TO OUTSIDE IN ACCORDANCE WITH ALL APPLICABLE CODES.
 SMOKE ALARMS SHALL BE HARD WIRED IN SERIES WITH BATTERY BACKUP POWER IN ACCORDANCE WITH APPLICABLE CODE.

12. VERIFY OUTLET/SWITCH LOCATIONS IN FIELD WITH OWNER AND ARCHITECT

13. TREATED SOLE PLATE WITH ½ BOLT @4' O.C., BOLT MUST EXTEND AT LEAST 7" INTO CONC. ALL SILL PLATE LUMBER AND ANY LUMBER IN CONTACT WITH CONCRETE OR CMU BLOCKING TO BE MOISTURE TREATED.

14. ALL INTERIOR WALLS TO BE CONSTRUCTED OUT OF 6" MTL STUD @ 16" O.C. U.N.O. WALLS TO RECIEVE SOUND INSULATION AND 4" METAL COVE BASE U.N.O.
15. ALL EXTERIOR WALLS TO BE CONSTRUCTED OUT OF 6" METAL STUD @16" O.C. WITH BATT OR SPRAY FOAM INSULATION, U.N.O.

16. REFER TO FINISH PLAN FOR ALL FINISH SCHEDULES.17. ENSURE EGRESS REQUIREMENTS ARE MET PER COD

17. ENSURE EGRESS REQUIREMENTS ARE MET PER CODE.18. COORDINATE HOSE BIB LOCATIONS IN FIELD W/ OWNER AND ARCHITECT.

19. CONTRACTOR TO PROVIDE MOCK UP FOR APPROVAL OF ALL EXTERIOR FINISH MATERIALS AND FENESTRATION PRIOR TO CONSTRUCTION.

20. CONTRACTOR TO FIELD VERIFY ALL EXISTING UNDERGROUND UTILITES PRIOR TO CONSTRUCTION.
21. ANY DISCREPENCIES NOTED IN PLANS MUST BE REPORTED TO THE ARCHITECT IN WRITING PRIOR TO

CONSTRUCTION. CONTRACTOR AND ALL SUB CONTRACTORS ARE RESPONSIBLE FOR NOTIFICATION

OF ANY DESCREPENCY, REGARDLESS OF WHERE THEY MAY APPEAR IN THE CONSTRUCTION DOCUMENT SET.

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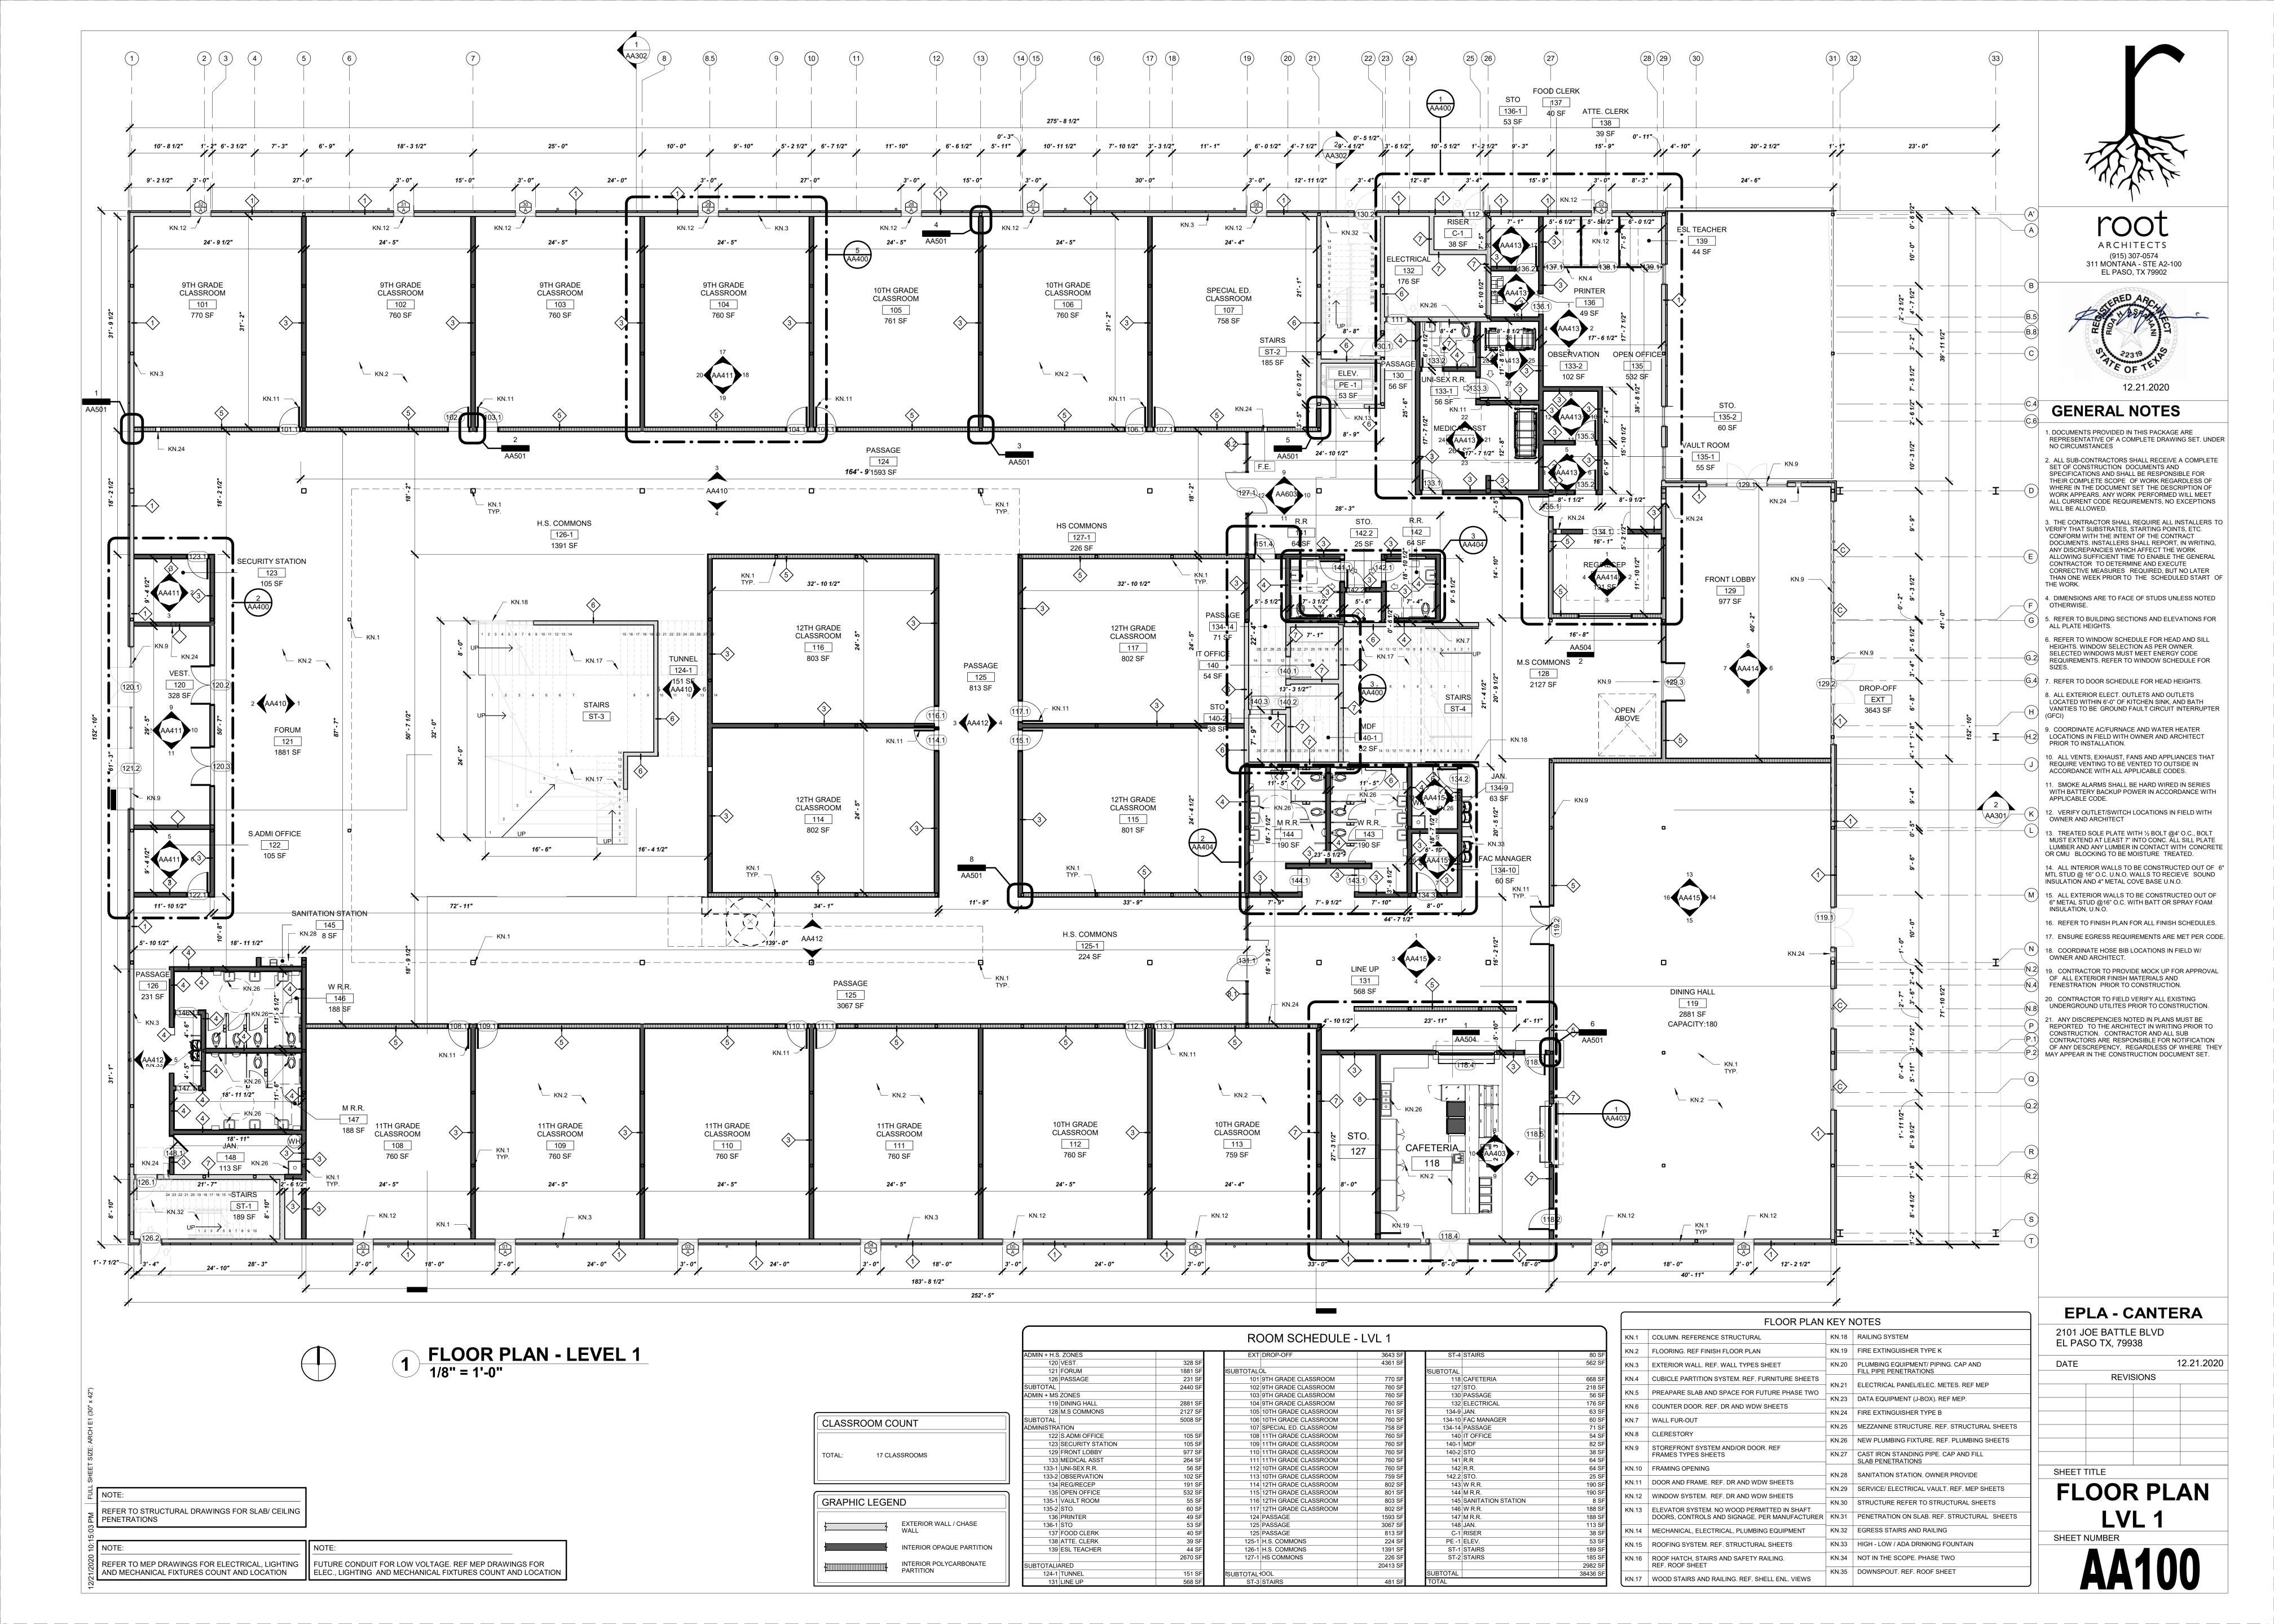
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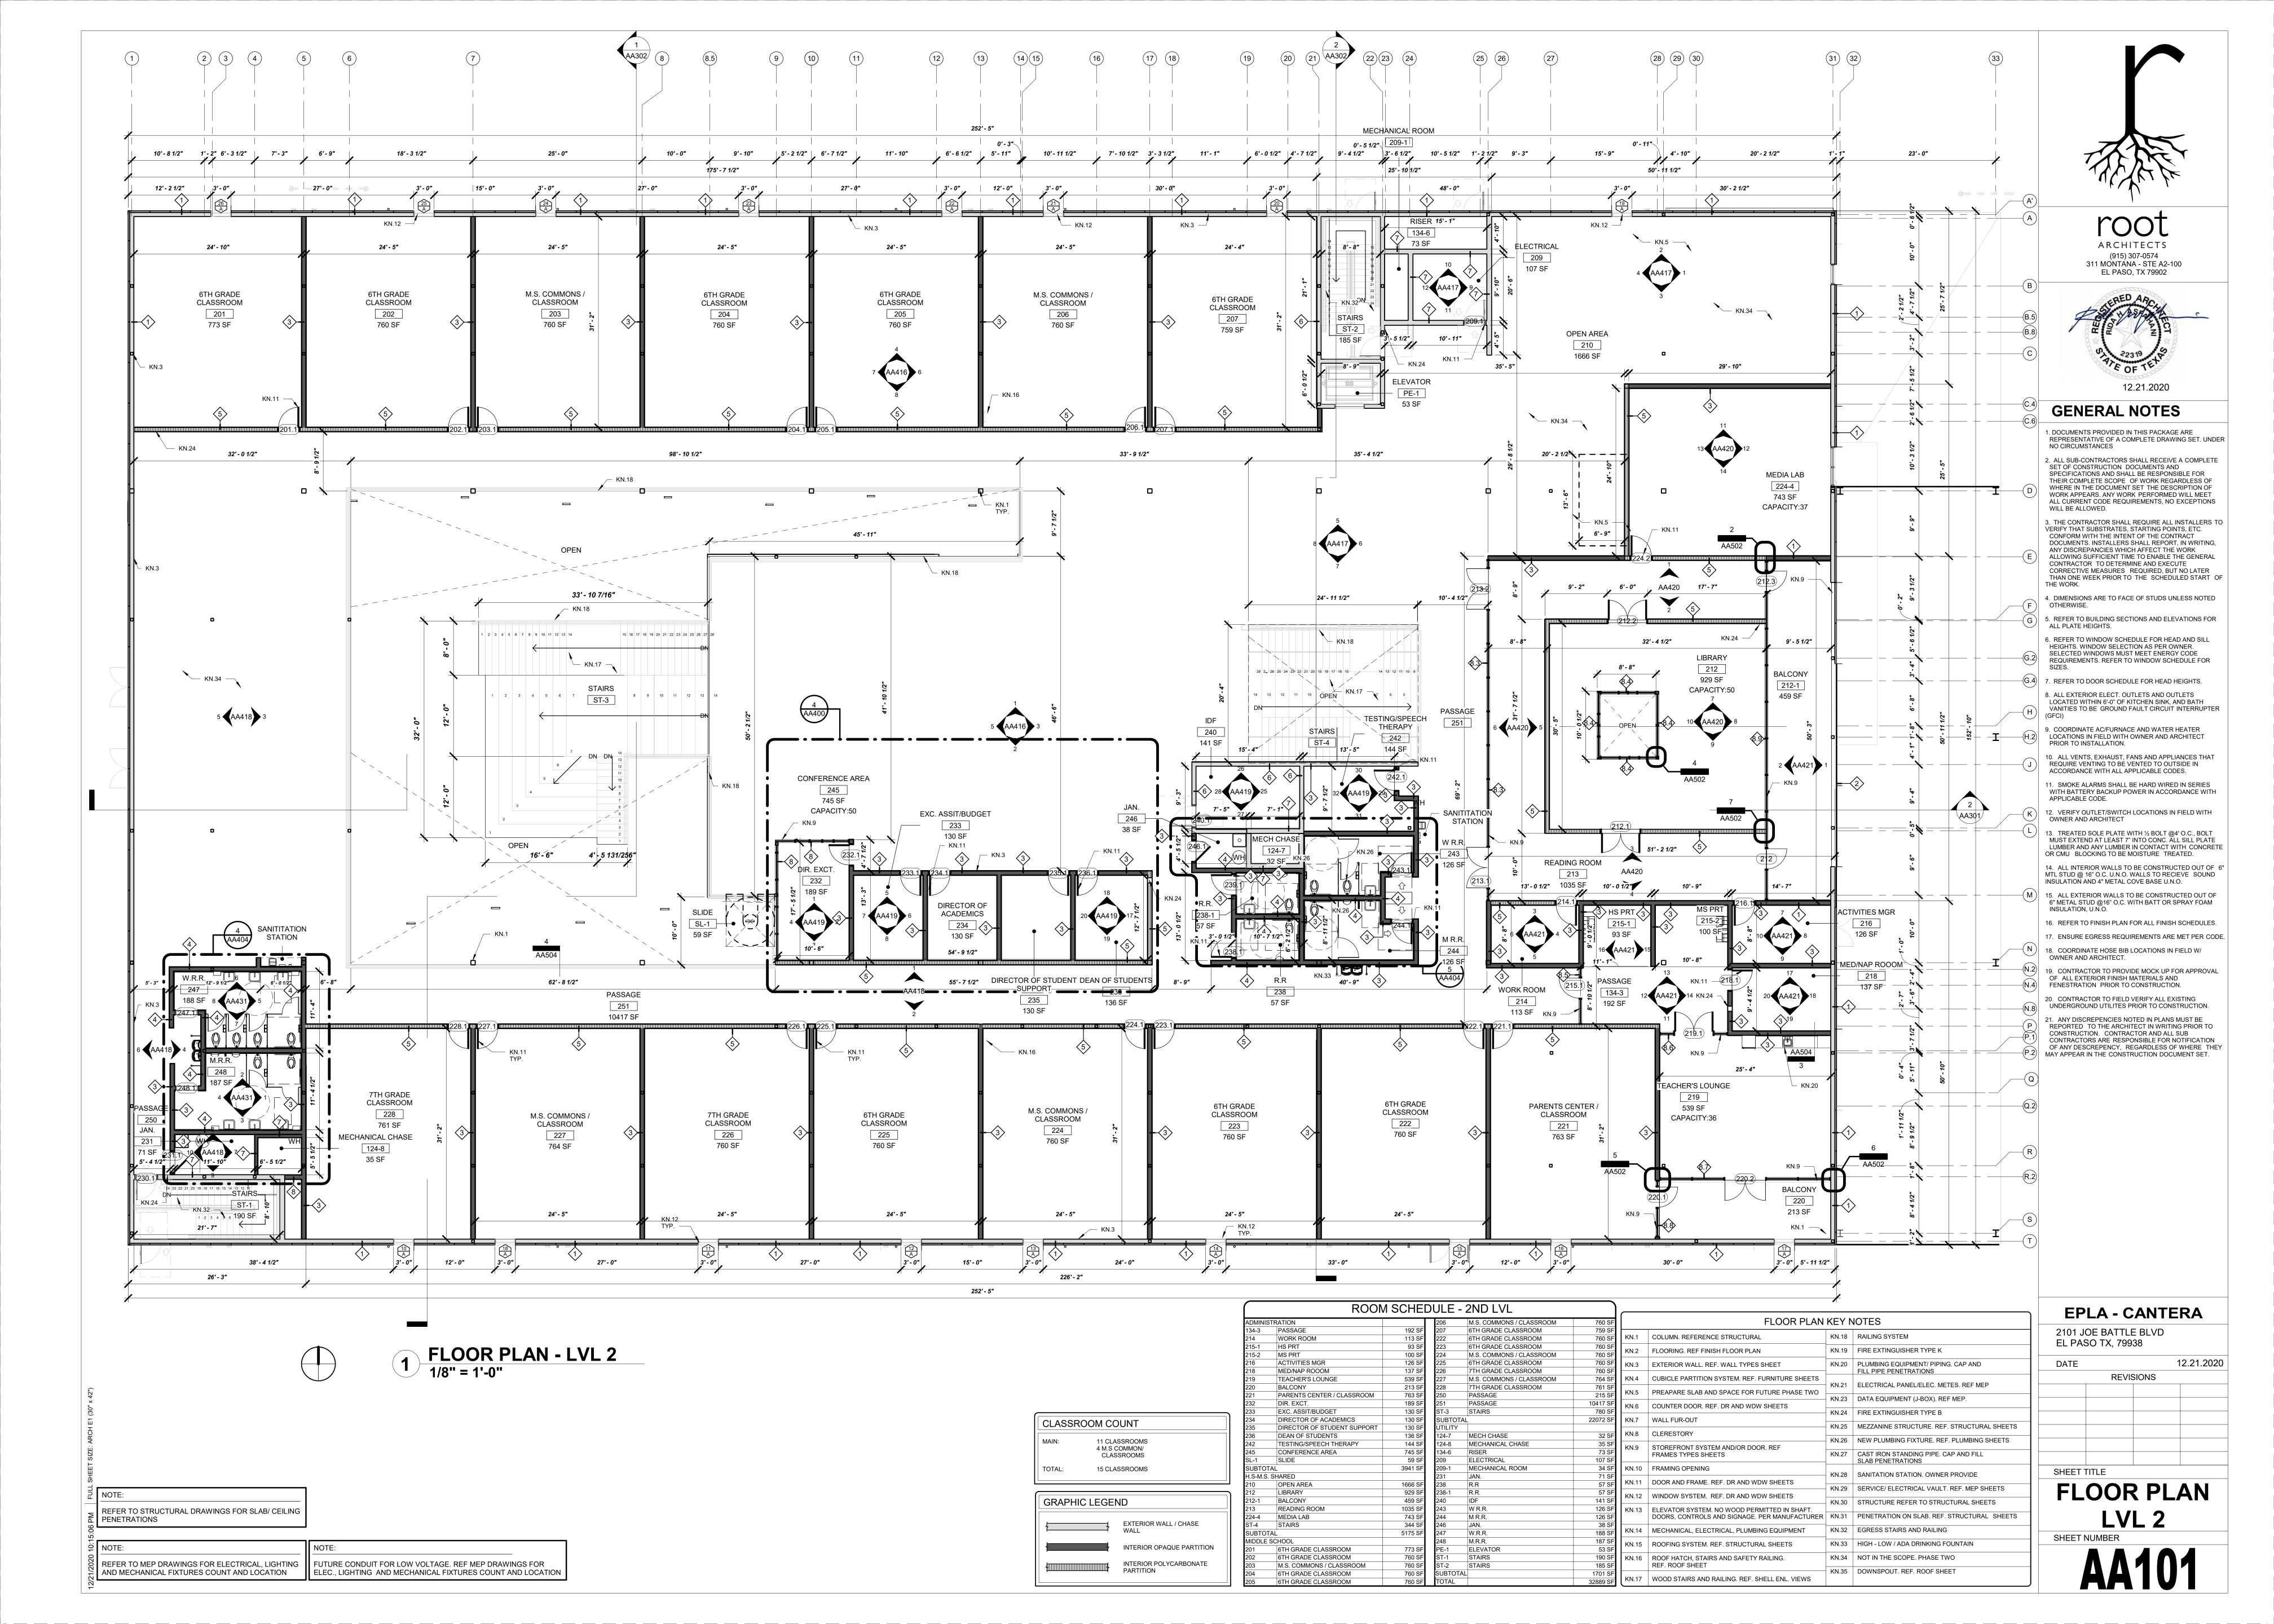
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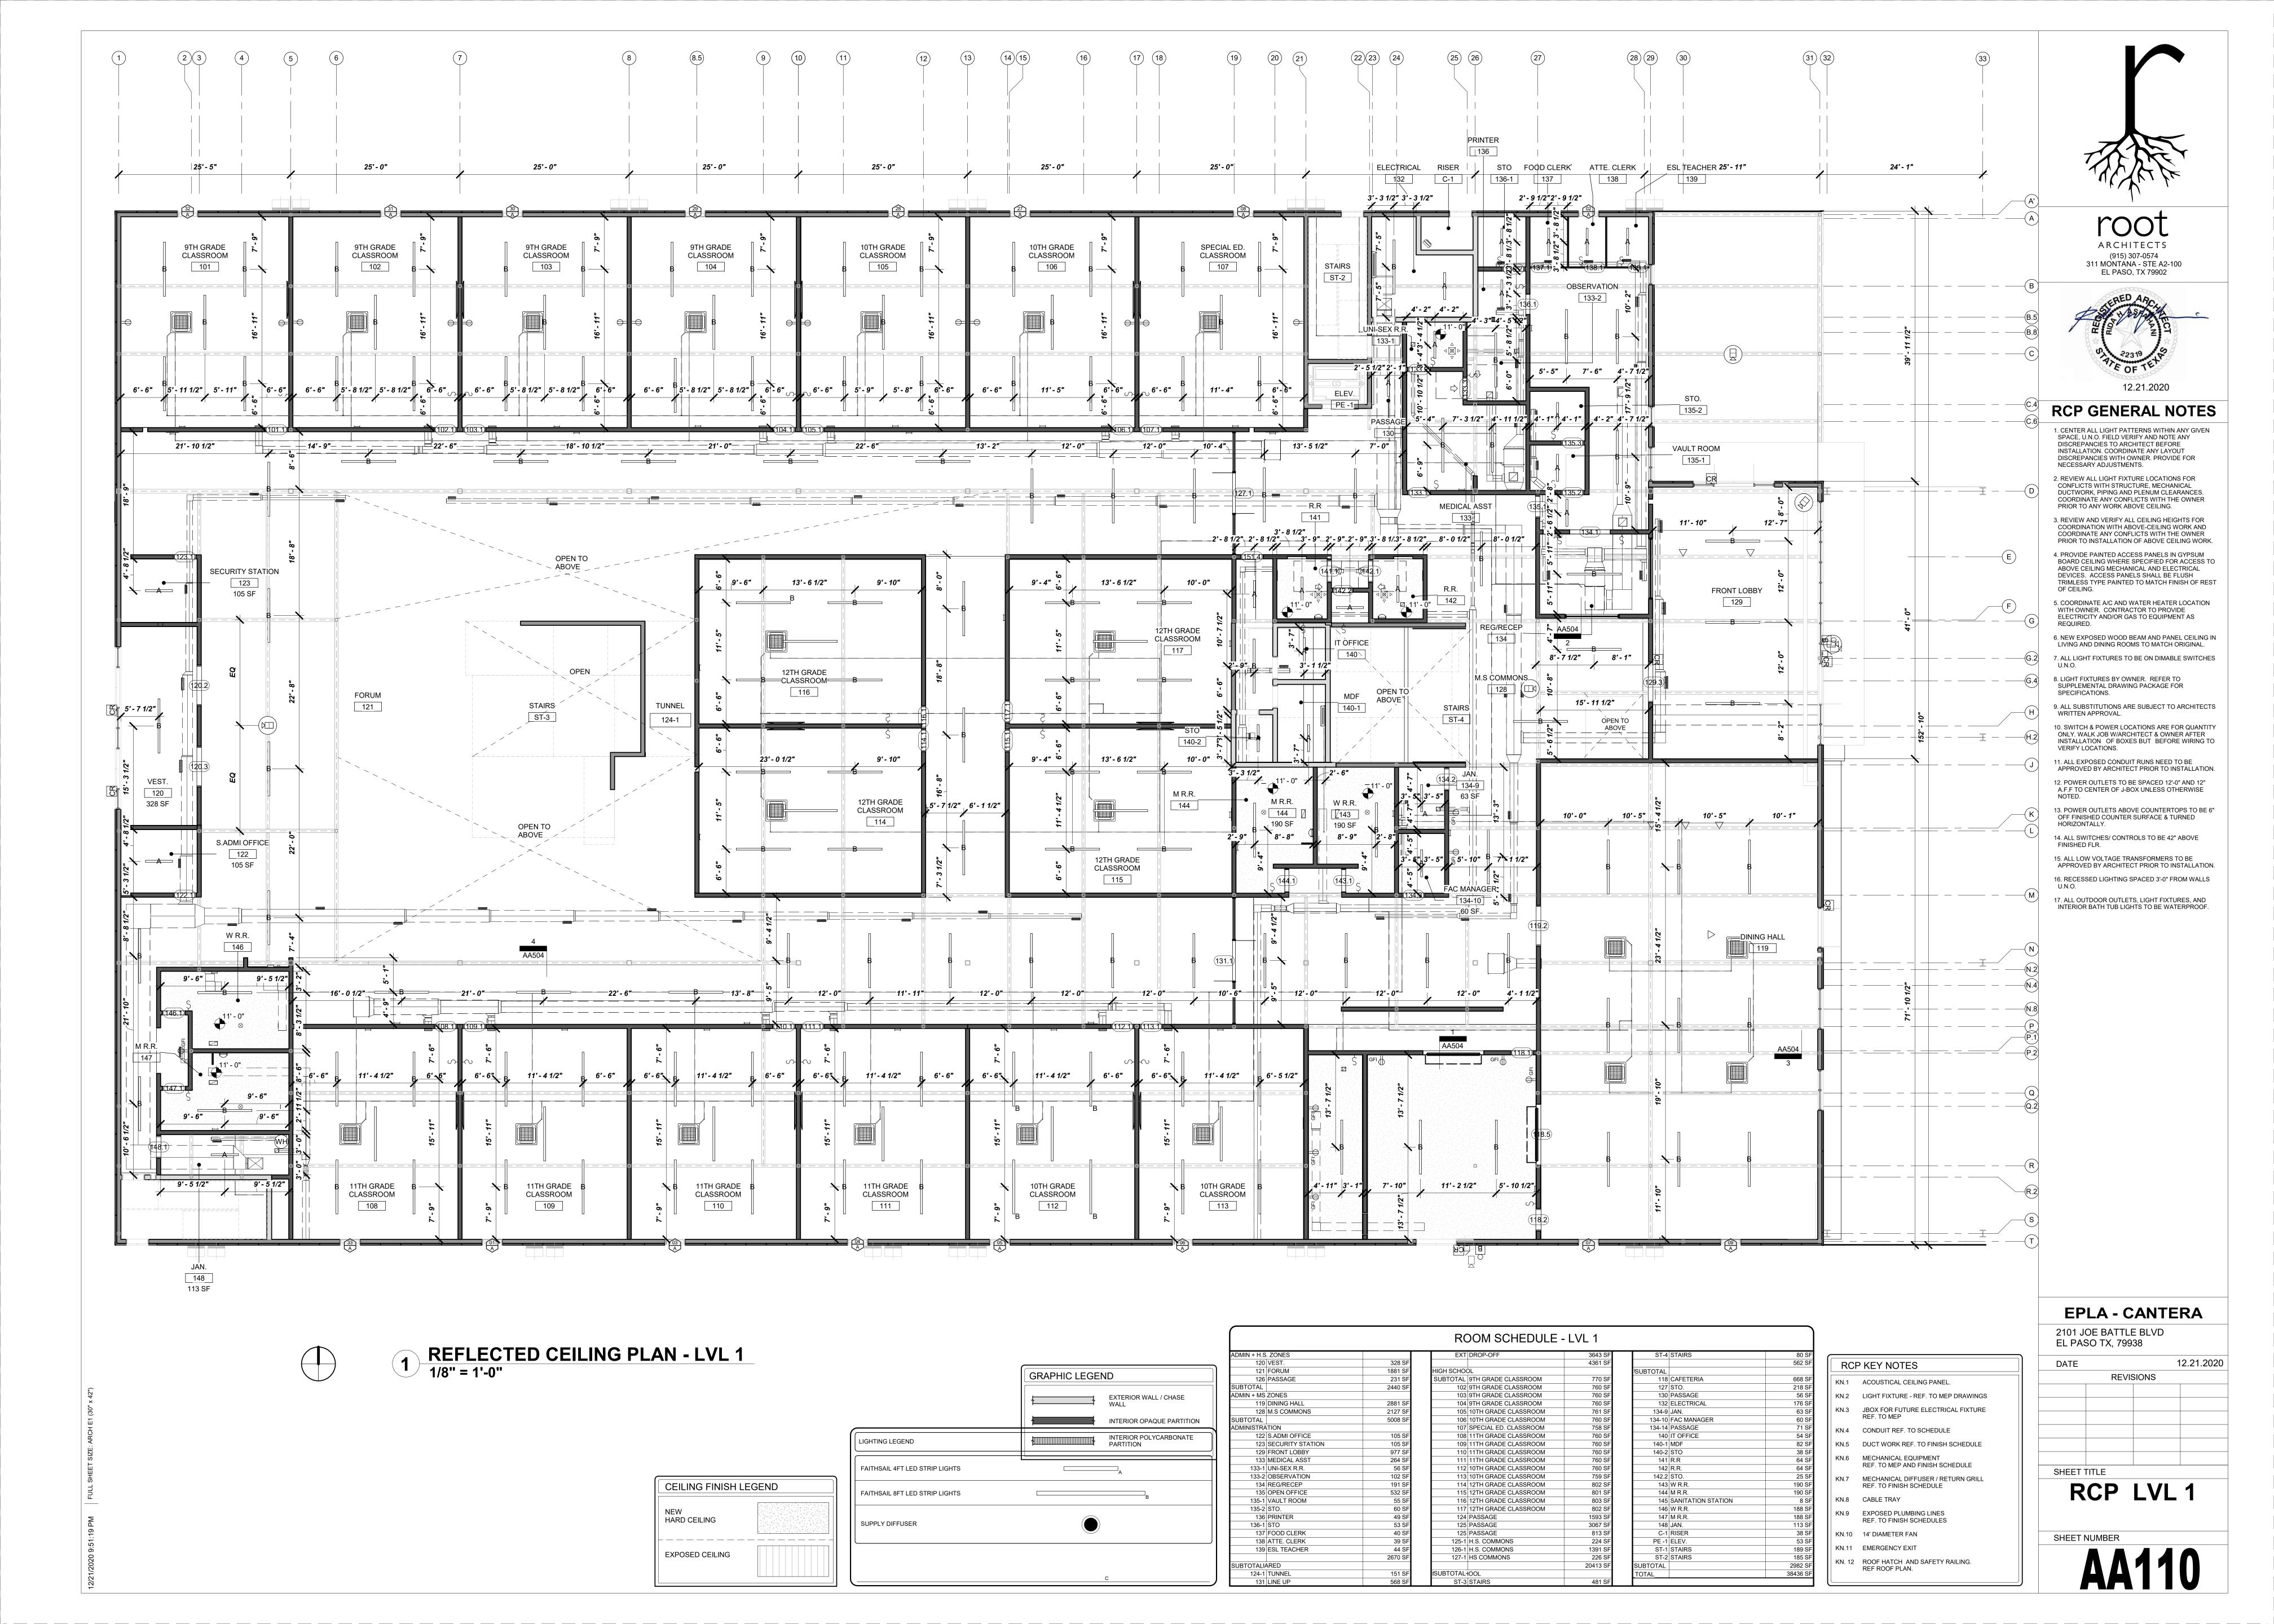
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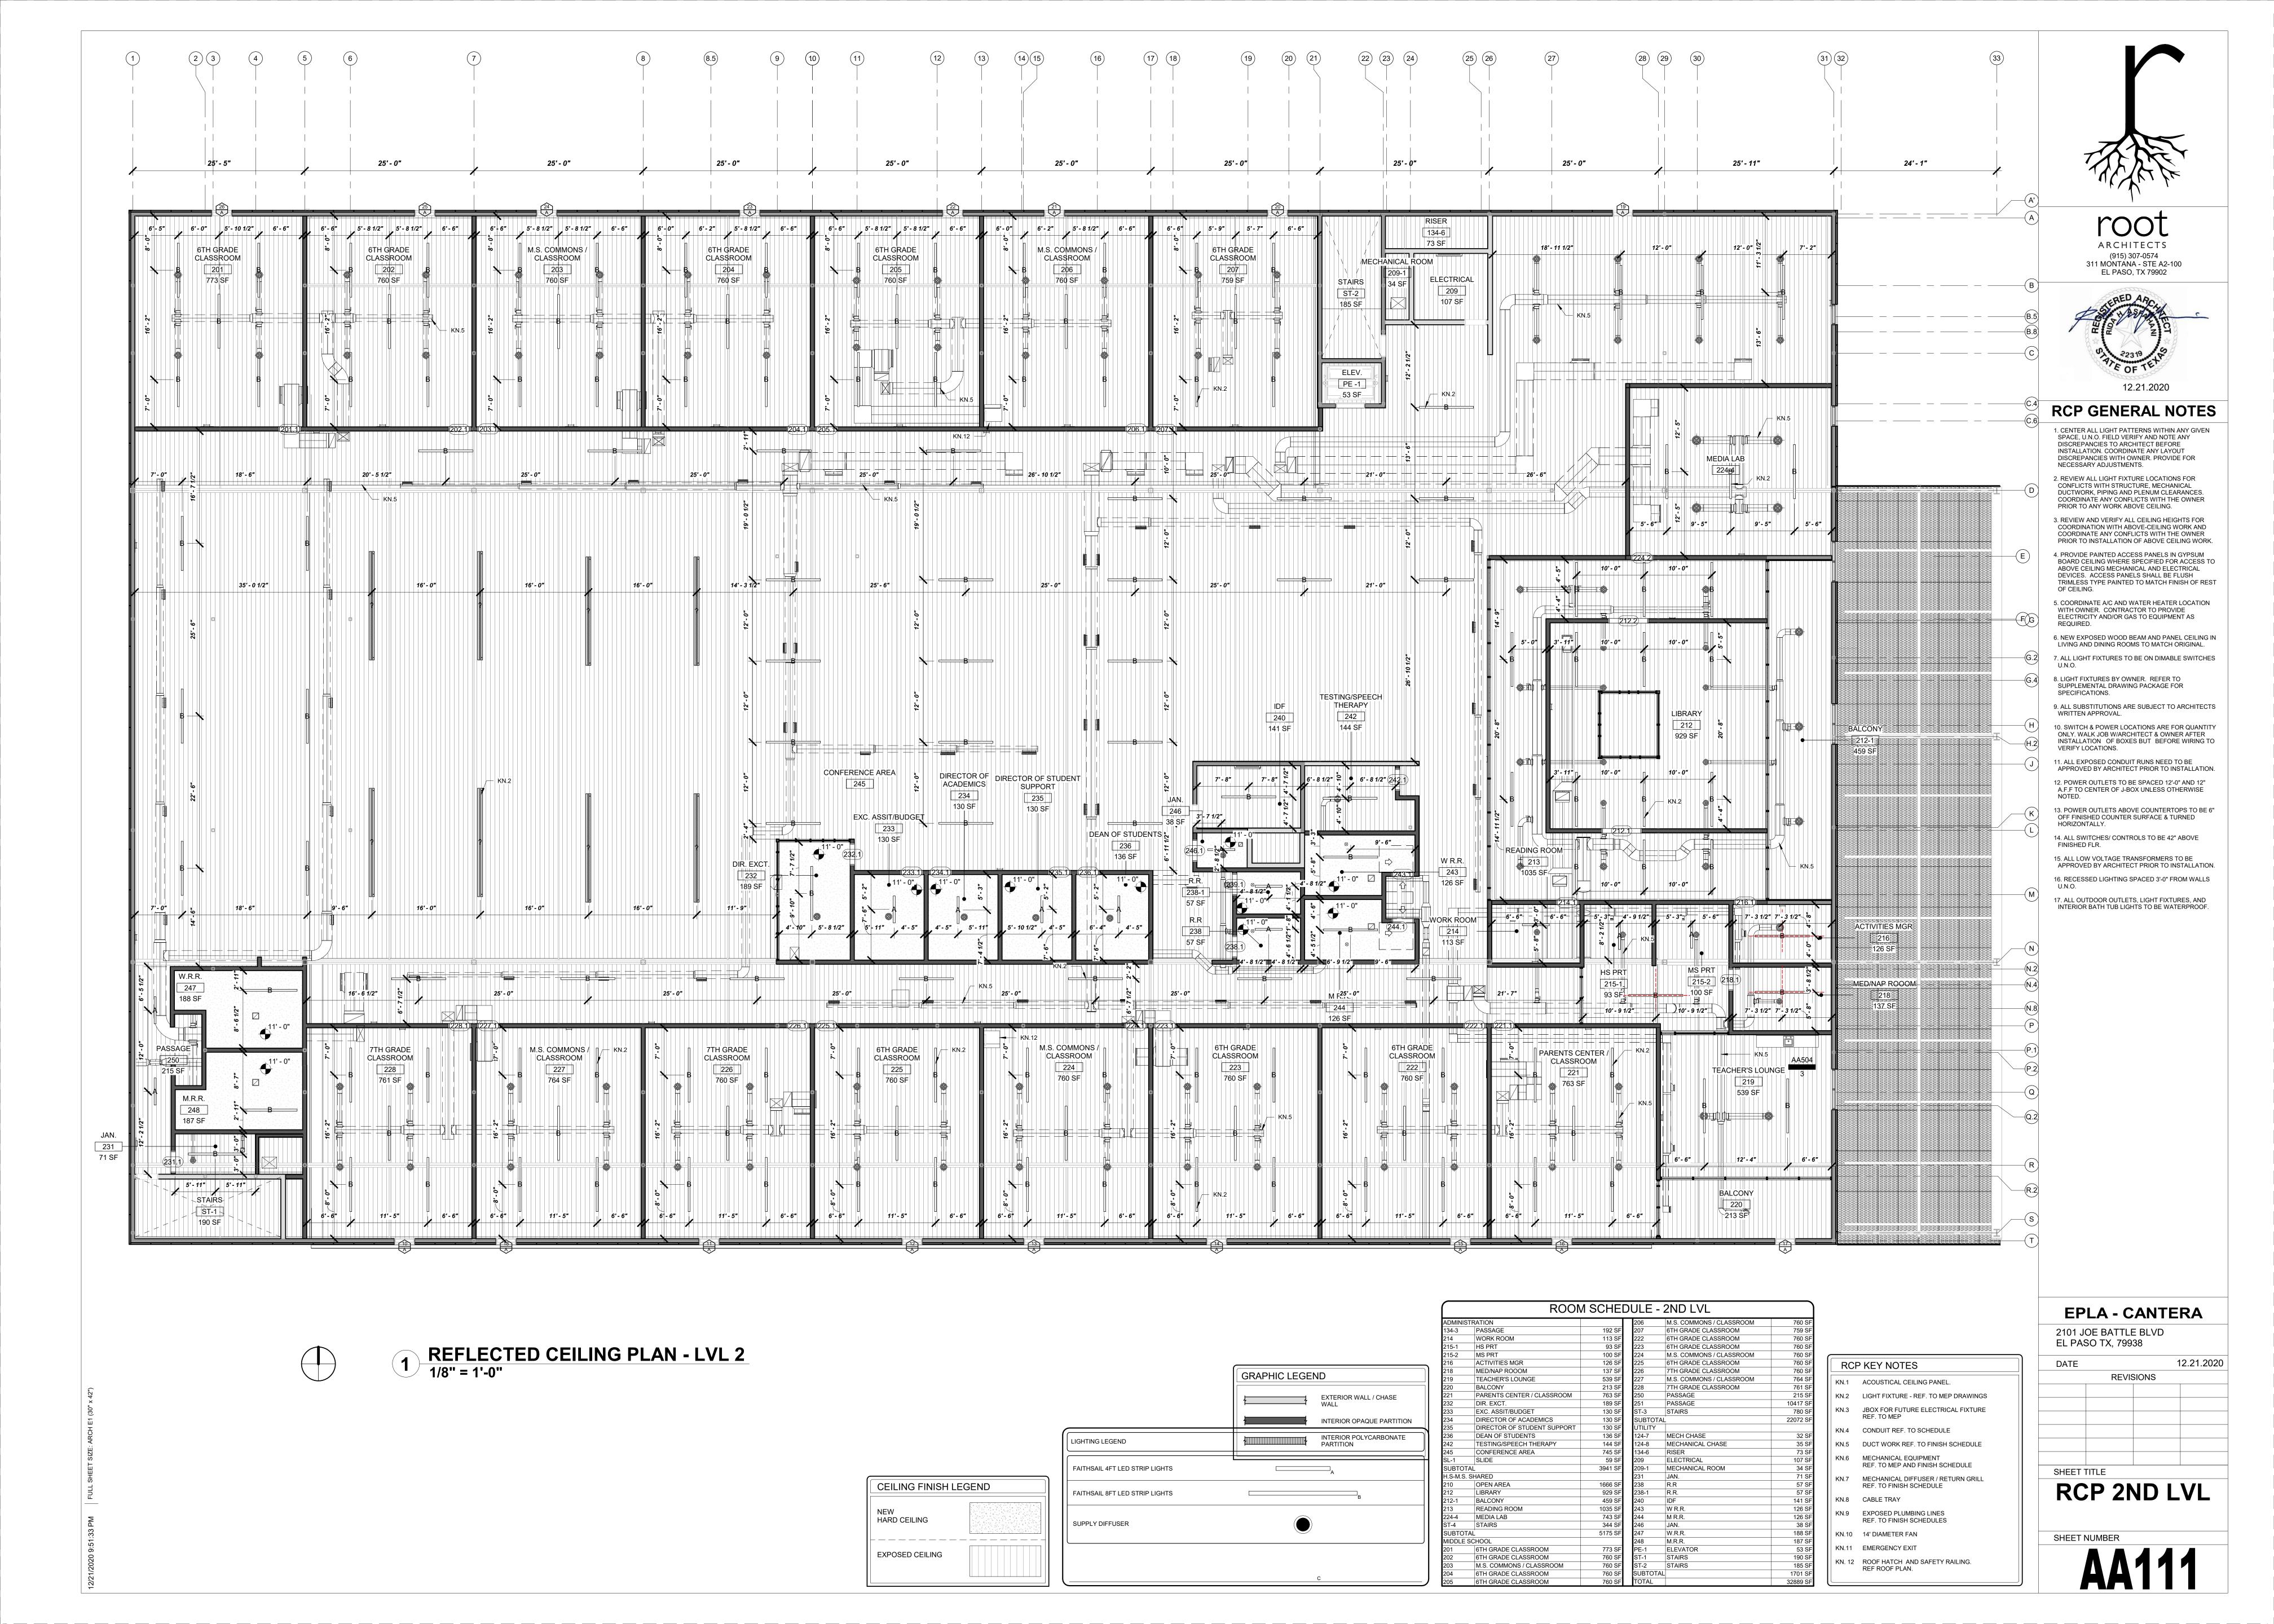
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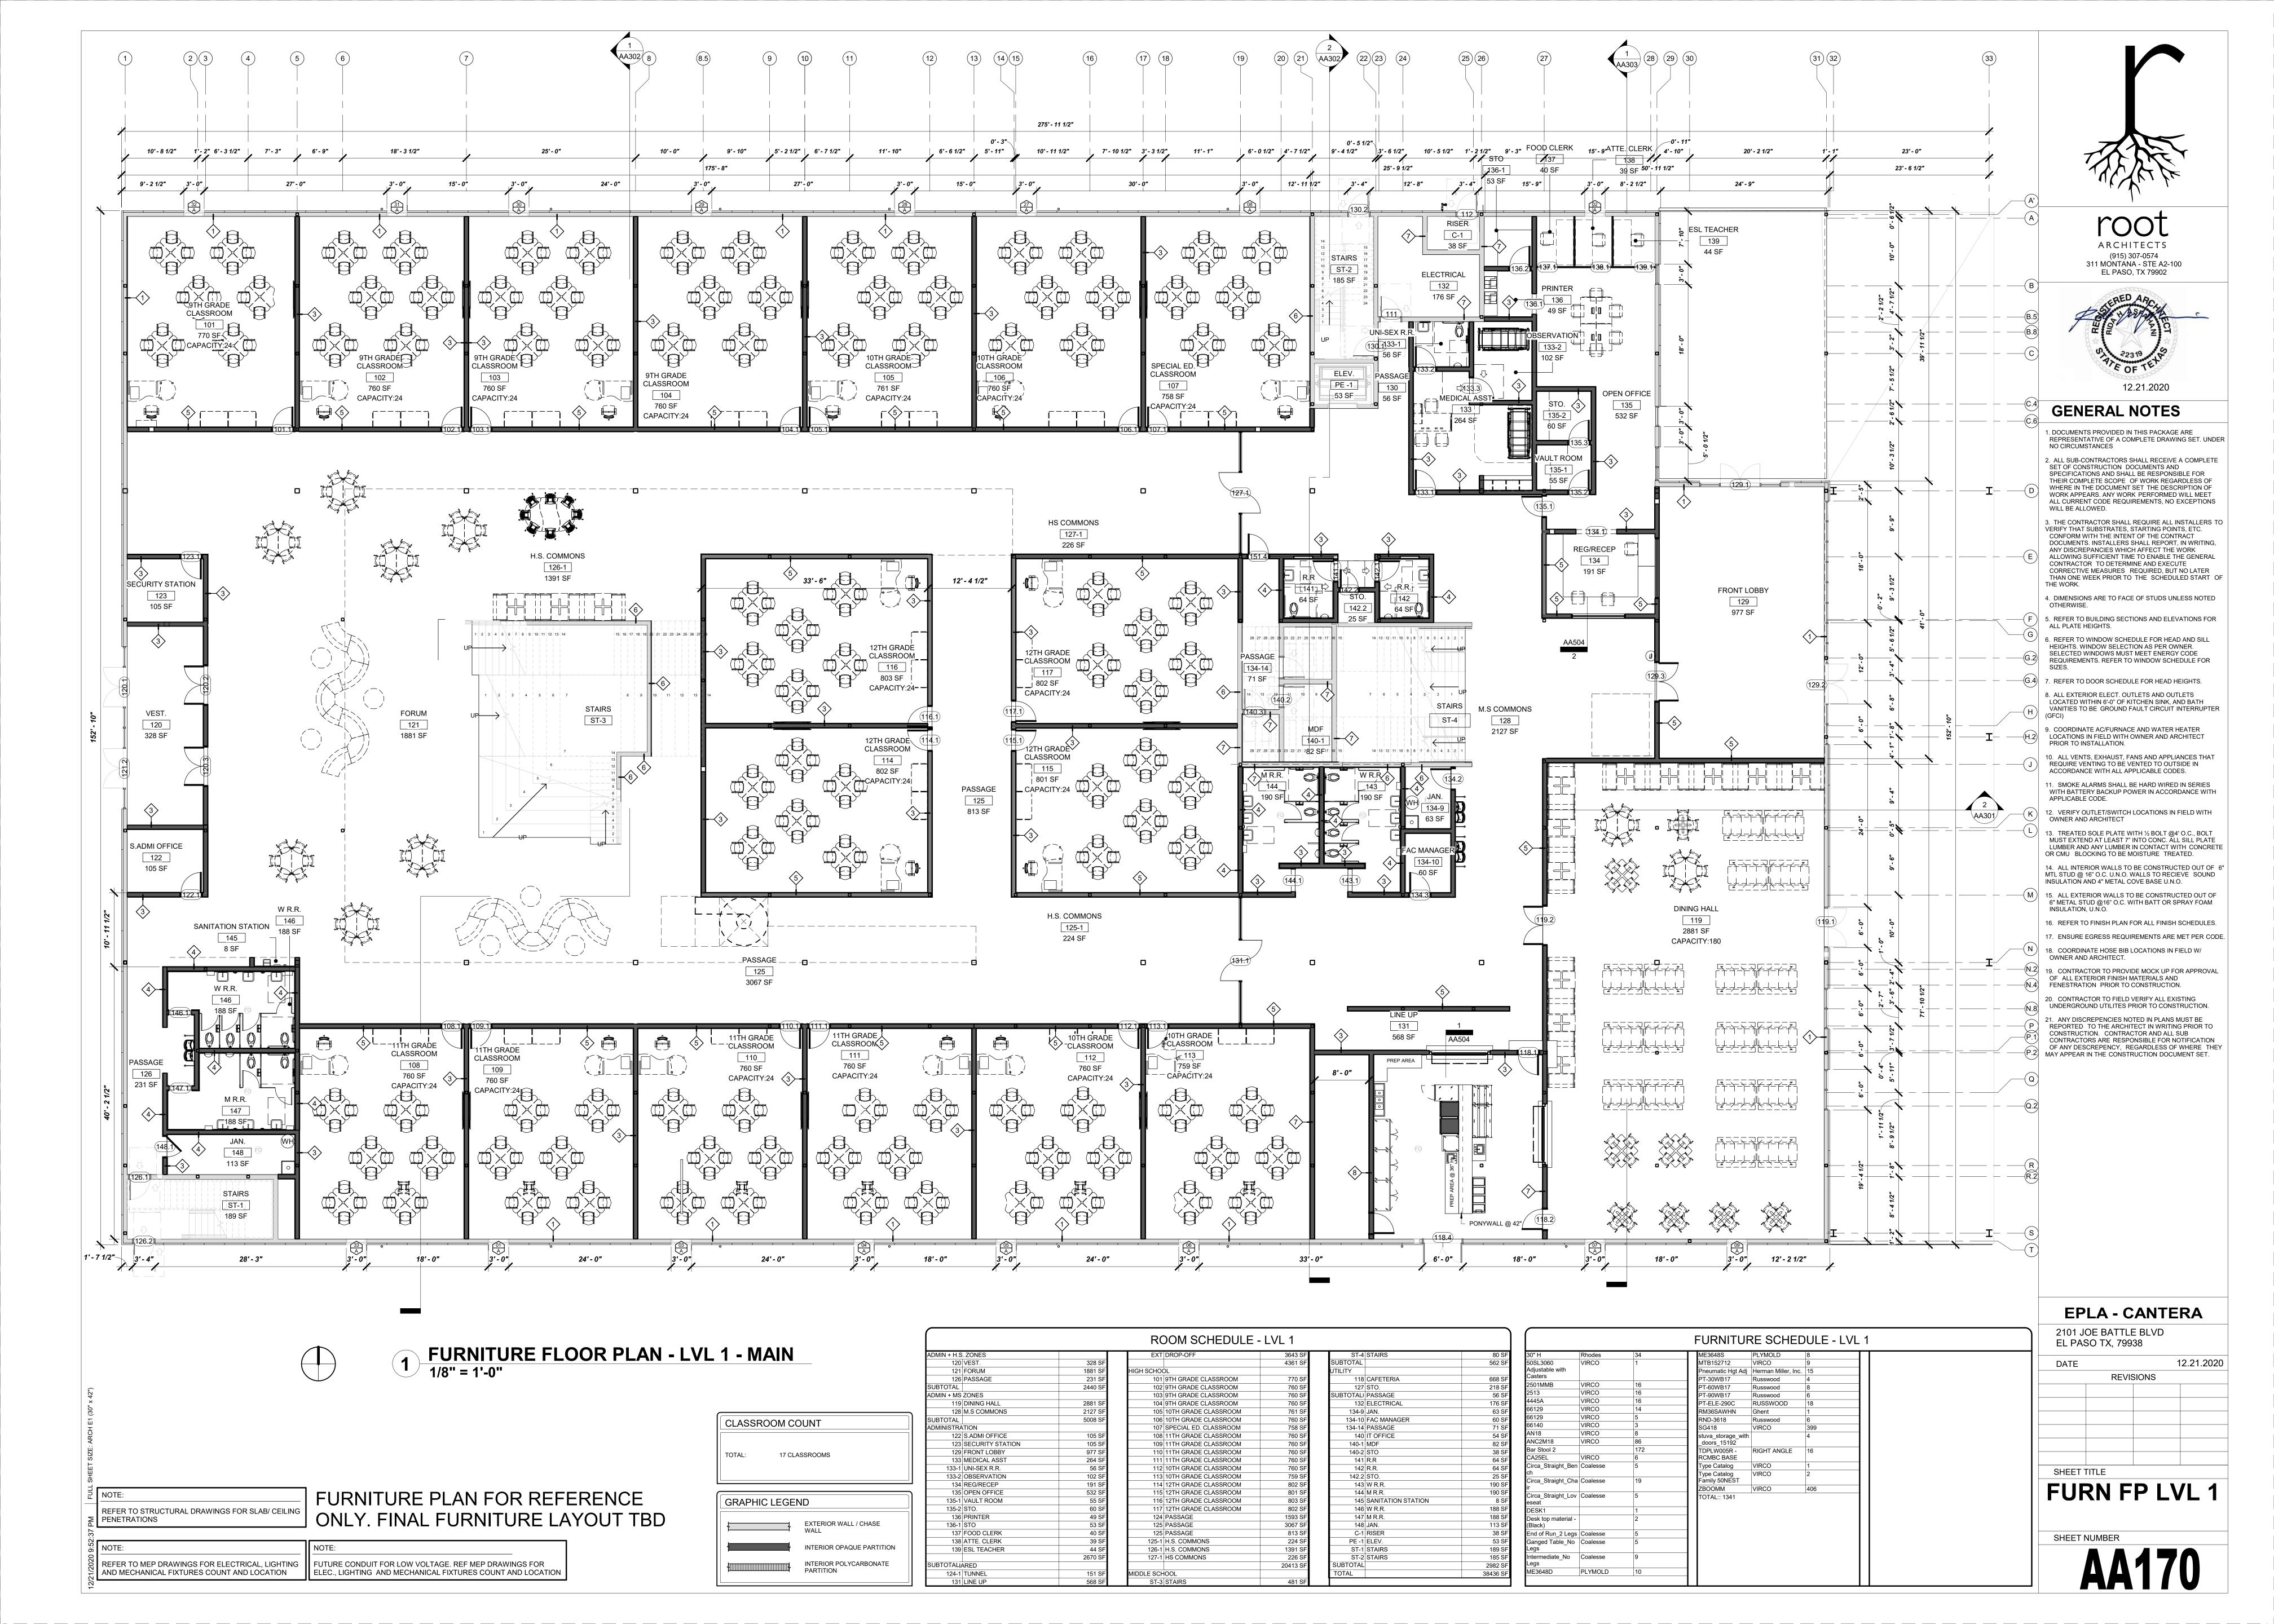
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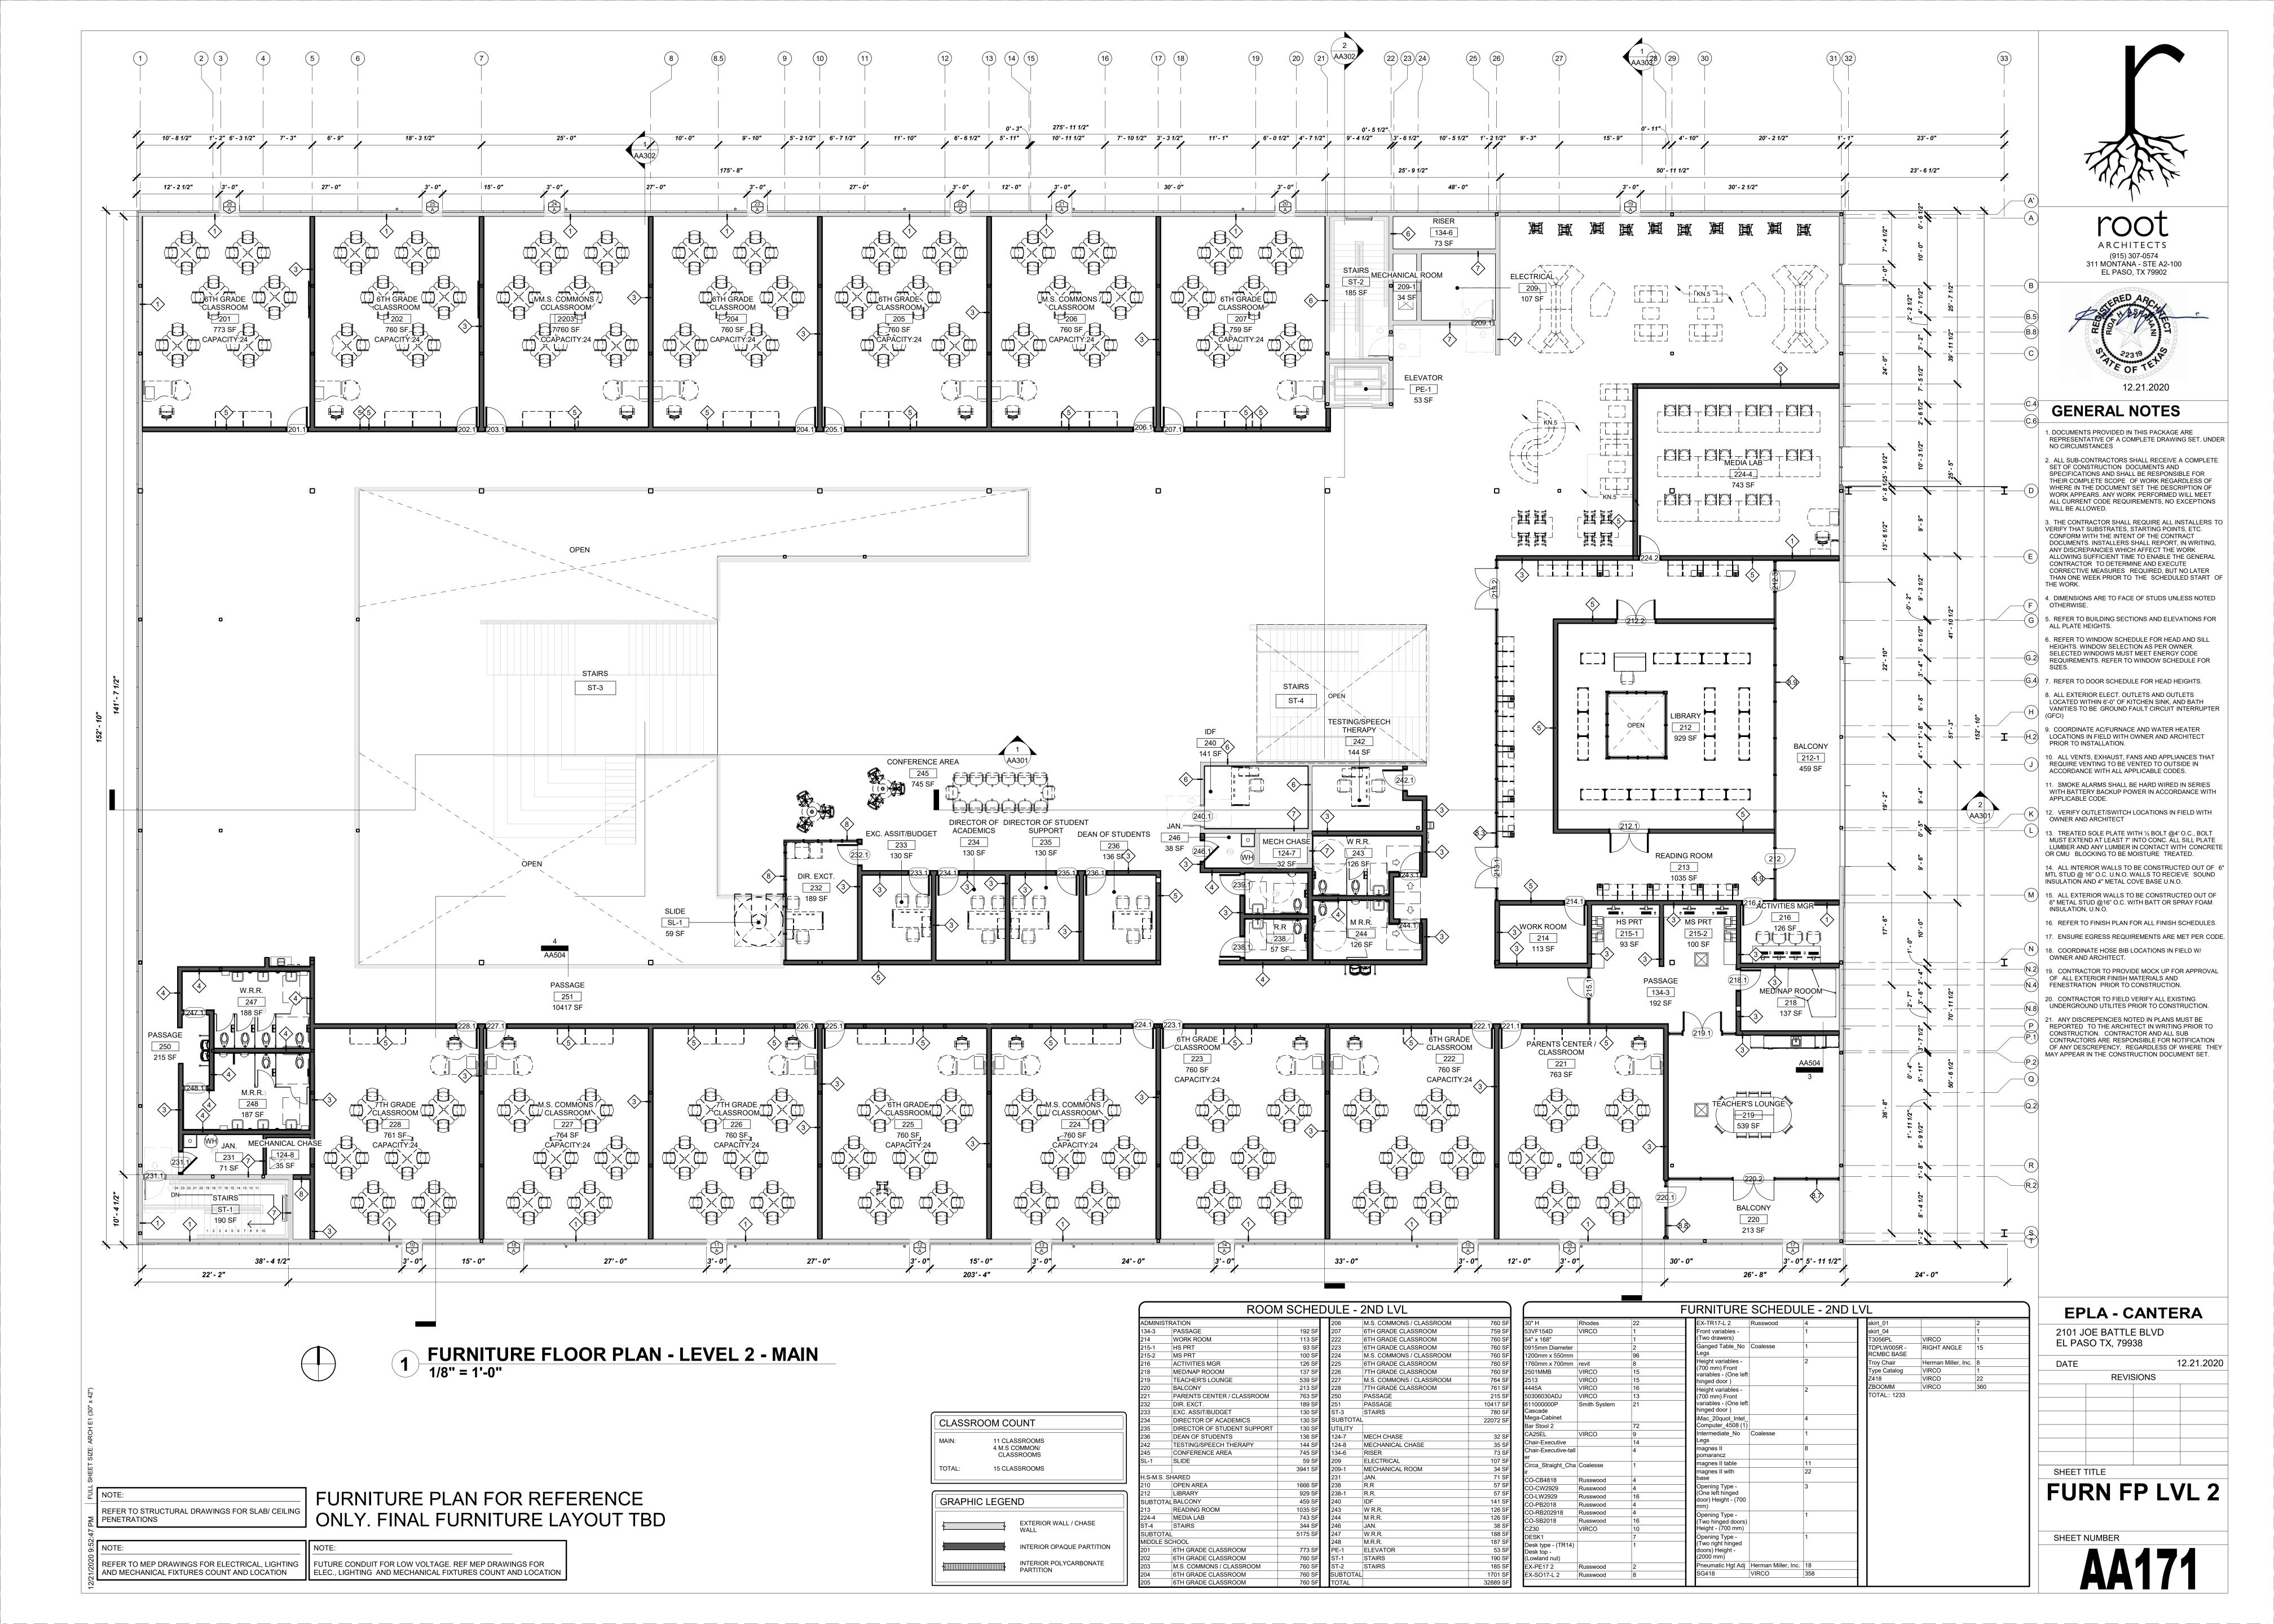












ELECTRICAL SPECIFICATIONS

- 1. THE ELECTRICAL WORK SHALL BE PERFORMED IN STRICT ACCORDANCE WITH THE APPLICABLE AND ADOPTED PROVISIONS OF THE NATIONAL ELECTRICAL CODE, ENERGY CODE AS ADOPTED AND INTERPRETED BY THE STATE OF TEXAS AND THE NATIONAL FIRE PROTECTION ASSOCIATION (NFPA) REGULATIONS, CURRENT ADOPTED EDITION REGARDING MECHANICAL SYSTEMS. FIRE SYSTEMS AND ELECTRICAL SYSTEMS. ALL MATERIALS AND LABOR NECESSARY TO COMPLY WITH RULES. REGULATIONS AND ORDINANCES SHALL BE PROVIDED. WHERE THE DRAWINGS INDICATE MATERIALS OR CONSTRUCTION IN EXCESS OF CODE REQUIREMENTS, THE OWNER, ARCHITECT AND ENGINEERS ARE FREE AND HARMLESS FROM LIABILITY OF ANY NATURE OR KIND ARISIN FROM HIS FAILURE TO COMPLY WITH ALL APPLICABLE CODES AND ORDINANCES.
- 2. ALL WORK SHALL CONFORM WITH FEDERAL, STATE, AND LOCAL CODES RULES, AND REGULATIONS. ALL WORK SHALL BE PERFORMED BY A LICENSED CONTRACTOR IN A FIRST CLASS WORKMANLIKE MANNER. THE SYSTEMS SHALL BE INSTALLED COMPLETE AND FULLY OPERATIVE UNLESS OTHERWISE INDICATED.
- 3. ALL MATERIALS SHALL BE NEW, EXCEPT WHERE NOTED OTHERWISE. AL WORK SHALL PRESENT A NEAT AND MECHANICAL APPEARANCE WHEN COMPLETED AND SHALL BE EXECUTED IN A WORKMANLIKE MANNER.
- 4. REQUIRED INSURANCE SHALL BE PROVIDED BY THIS CONTRACTOR FOR PROTECTION AGAINST PUBLIC LIABILITY AND PROPERTY DAMAGE FOR THE DURATION OF WORK. CONTRACTOR SHALL SECURE AND PAY ALL PERMITS, FEES, INSPECTIONS, AND TESTS UNLESS OTHERWISE INDICATE COORDINATE WITH ARCHITECT, ENGINEER OR OWNER, SUBSTITUTIONS REQUESTED BY THE CONTRACTOR SHALL BE PAID FOR BY THE CONTRACTOR.
- 5. CONTRACTOR SHALL SUBMIT SPECIFIC INFORMATION ON LIST OF EQUIPMENT AND PRINCIPAL MATERIAL SPECIFIED. CONTRACTOR SHALL INDICATE AND/OR PROVIDE NAME OF MANUFACTURERS, CATALOG AND MODEL NUMBERS, CUT SHEETS, AND SUCH SUPPLEMENTARY INFORMATION AS NECESSARY FOR EVALUATION. MINIMUM OF SIX (4) COPIES, ELECTRONIC FORMAT, OR AS DIRECTED BY THE ENGINEER. EAG SECTION SHALL BE SUBMITTED AND SHALL INCLUDE ALL ITEMS MENTIONED BY MODEL NUMBER AND/OR MANUFACTURER'S NAME IN TH SPECIFICATION OR IN SCHEDULES ON THE DRAWINGS.
- 6. PROVIDE THE OWNER WITH THREE (3) COPIES OF ALL INSTALLATIONS INSTRUCTIONS, PRODUCT DATA SUBMITTAL INFORMATION, WARRANTIES, CONTACT INFORMATION DURING WARRANTY PERIOD. AND BALANCING REPORTS IN 3-RING BINDERS.
- 7. ALL SYSTEMS AND COMPONENTS SHALL BE APPROVED FOR THE PURPOSE FOR WHICH IT IS INSTALLED. ALL EQUIPMENT AND MATERIAL SHALL BE NEW AND FROM ESTABLISHED AMERICAN SUPPLIERS UNLESS OTHERWISE INDICATED.
- 8. THE CONTRACTOR SHALL COORDINATE WITH OWNER, ARCHITECT, AND ENGINEER ANY WORK THAT HAS THE POTENTIAL TO HINDER ELECTRICA SERVICES TO AREA OUTSIDE OF THIS CONTRACT. ALL SHUT-DOWNS OF TIE-INS RELATING TO THESE SYSTEMS SHALL BE SCHEDULED AND SUBMITTED IN WRITING TO BE APPROVED BY THE OWNER'S FACILITY MANAGEMENT, OWNER, ARCHITECT, OR ENGINEER, CONTRACTOR SHALL SUBMIT IN WRITING A SCHEDULE FOR PHASING OF CONSTRUCTION THA INDICATES AREAS OF FIRST PRIORITY DURING EACH PHASE AND ANTICIPATED COMPLETION TIMES. SCHEDULES SHALL BE SUBMITTED A MINIMUM OF ONE WEEK PRIOR TO COMMENCING WORK. FACILITY MANAGEMENT, OWNER, ARCHITECT OR ENGINEER SHALL REVIEW THESE SCHEDULES AND NOTIFY CONTRACTOR OF ACCEPTANCE PRIOR TO COMMENCEMENT OF WORK.
- 9. CONTRACTOR SHALL FIELD VERIFY EXISTING CONDITIONS AND PROVIDE WRITTEN REPORT TO THE ARCHITECT OFFICE. THIS REPORT SHALL DESCRIBE EXISTING DAMAGE OR OTHER CONDITIONS THAT MAY INTERFERE WITH THIS PROPOSED NEW WORK. THIS SITE SURVEY SHALL ALSO INCLUDE VERIFICATION OF SIZES, LOCATIONS, AND CONDITIONS (EXISTING UTILITIES.
- 10. ALL WIRING SHALL BE RUN IN RIGID CONDUIT, INTERMEDIATE METALLIC CONDUIT (IMC) OR ELECTRICAL METALLIC TUBING (EMT) INSTALLED IN ACCORDANCE WITH THE NEC. MC CABLE IS ALLOWED FOR FIXTURE WHIPS ONLY. ALUMINUM CONDUIT SHALL NOT BE USED UNLESS SPECIFICALLY INDICATED ON THE DRAWINGS. EMT OR ALUMINUM CONDUIT SHALL NOT BE INSTALLED IN CONCRETE SLABS OR BELOW GRADE. MINIMUM SIZE 3/4 INCH. ALL CONDUITS CONTAINING POWER CONDUCTORS SHALL CONTAIN A EQUIPMENT GROUND CONDUCTOR SIZED IN ACCORDANCE WITH THE NEC. A #9 PULL WIRE SHALL BE INSTALLED IN EACH EMPTY CONDUIT.
- 11. INCREASE BRANCH CIRCUIT WIRE SIZE AS REQUIRED TO PREVENT 100' - #8 AWG.
- 12. THE CONDUIT SYSTEM AND NEUTRAL CONDUCTOR OF THE WIRING SYSTEM SHALL BE GROUNDED IN ACCORDANCE WITH THE NEC AND ALL LOCAL CODES AND ORDINANCES. GROUNDING AND BONDING SHALL COMPLY WITH ALL THE APPLICABLE REQUIREMENTS OF THE NEC.
- 13. USE THE FOLLOWING WIRING COLOR CODE: A. FOR WIRE SIZES 10 AWG AND SMALLER, INSTALL WIRE COLORS IN

	,, , , , , , , , , , , , , , , , , ,	0 / 11 10 0 11 11 12 12 11 11 11 11 12 11 11 12 11 11	
ACCORDANC	E WITH THE	FOLLOWING:	
1:	20/208	277/480	
PHASE A	,	BŔOWN	
PHASE B	RED	ORANGE	
PHASE C	BLUE	YELLOW	
NEUTRAL	WHITE	GRAY	
GROUND	GREEN	GREEN	
SWITCH P	INK/PURPLE	PINK/PURPLE	

- 14. BURIED ELECTRICAL CONDUITS SHALL BE MARKED PER CODE REQUIREMENTS WITH UNDERGROUND WARNING TAPE 3" BELOW FINISHED GRADE. TAPE SHALL BE 4" WIDE COLORED RED WITH SUITABLE WARNING LEGEND PER ASMB A13.1.
- 15. CONTRACTOR TO PROVIDE BLANK COVER FOR ALL J-BOXES AND WEATHERPROOF COVERS FOR J-BOXES IN WET LOCATIONS.
- TEST PROVISIONS OF THE MOST CURRENT ANSI/SCTE77. WHEN MULTIPLE "TIERS" ARE SPECIFIED THE BOXES MUST PHYSICALLY ACCOMMODATE AND STRUCTURALLY SUPPORT COMPATIBLE COVER WHILE POSSESSING THE HEIGHT TIER RATING. ALL COVERS ARE REQUIRED TO HAVE THE TIER LEVEL RATING EMBOSSED ON THE SURFACE. IN NO ASSEMBLY CAN THE COVER DESIGN LOAD EXCEED THE DESIGN LOAD OF THE BOX. ALL COMPONENTS IN AN ASSEMBLY (BOX & COVER) ARE MANUFACTURED USING MATCHED SURFING TOOLING. INDEPENDENT THRID PARTY VERIFICATION OR TEST REPORTS STAMPED BY A REGISTERED PROFESSIONAL ENGINEER CERTIFYING THAT ALL TEST PROVISIONS OF THIS SPECIFICATION HAVE BEEN MET ARE REQUIRED WITH EACH SUBMITTAL. CONTRACTOR TO ENSURE EXACT LOCATION AND PLACEMENT OF BOXES AND COVERS AND PROVIDE THE RATING REQUIRED BY LOCAL AND NATIONAL CODES
- 17. ELECTRICAL PANELS SHALL BE PANELBOARDS, HAVE COPPER BUSS, BOLTED CIRCUIT BREAKERS, KAIC RATING AS NOTED. PROVIDE TYPED AND LAMINATED COMPLETE SCHEDULE.
- 18. ALL DISCONNECTS SHALL BE HEAVY DUTY RATED.

ELECTRICAL SYMBOL LEGEND

1. THESE SYMBOLS COMPRISE A STANDARD LIST; NOT ALL SYMBOLS MAY APPEAR ON THIS PROJECT.

ICE	. THESE SYN	MBOLS COMPRISE A STANDARD LIST; NOT A	LL SYME	BOLS MAY AP	PEAR ON THIS PROJECT.								OD AMD	AMPERE	NEO	NATIONAL FLECTRIC CORE	CONTRACTOR	MEANS THE PERSON(S), FIRM OR COMPANY WHOSE TENDER FOR
Y	ARCHITECT	TING HEIGHTS ARE TO CENTER OF DEVICE A TURAL WALL ELEVATIONS OR AS NOTED SPE INTED HEIGHTS LISTED BELOW.										,	OR AMP	AMP FUSED	NEC NEUT	NATIONAL ELECTRIC CODE NEUTRAL		THE ELECTICAL INSTÀLLATION HAS BEEN ACCEPTED BY THE EMPLOYER AND INCLUDE THE CONTRACTO'S PERSONAL REPRESENTATIVE, SUCCESSOR, AND PERMITTED ASSIGNS.(The
<u>,</u>		LIGHTING SYMBOLS			POWER SYMBOLS		SP	ECIAL SYSETEMS SYMBOLS		FIRE	ALARM SYSTEM SYMBOL	þ.	AFF AHU	ABOVE FINISH FLOOR AIR HANDLING UNIT	NEMA	NATIONAL ELECTRICAL MANUFACTURER ASSOCIATION		word "Contractor" may also mean sub-contractor as the context requires.)
E OF	SYMBOL	DESCRIPTION	MTG. HT.	SYMBOL	DESCRIPTION	MTG. HT.	SYMBOL	DESCRIPTION MTG. HT.	SYM	BOL	DESCRIPTION MTG. HT.		AIC	AMPS INTERRRUPTING CAPACITY	NFPA	NATIONAL FIRE PROTECTION ASSOCIATION		MEANS THE DRAWINGS REFEREED TO IN THE CONTRACT AND
	A	FLUORESCENT OR LED LIGHTING FIXTURE,		⊕	JUNCTION BOX			DATA /TEL DOV IN WALL 4" CO. DEED 1 DOV			PULL STATION WITH STOPPER, PROVIDE 4"] ,	AL	ALUMINUM	NF	NON FUSED	DRAWINGS	ANY MODIFICATION OF SUCH DRAWINGS APPROVED BY THE
ISING		CAPITAL LETTER INDICATES FIXTURE TYPE, REFER TO FIXTURE SCHEDULE			DUPLEX RECEPTACLE OUTLET, WALL MOUNTED	18"	K	DATA/TEL. BOX IN WALL, 4" SQ. DEEP J-BOX 18" WITH SINGLE GANG PLASTER RING, STUB UP			SQ. DEEP J-BOX WITH SINGLE GANG PLASTER 48"	,	AC	ABOVE COUNTER	NO	NORMALLY OPEN	Di William Co	ARCHITECT AND SUCH OTHER DRAWINGS AS MAY FROM TIME TO TIME BE FURNISHED OR APPROVED IN WIRING BY ARCHITECT.
		DIDECTIONAL HOUT LETTED IDIOATEC FIVILIDE		-				1" WITH PULLSTRING TO ABOVE ACCESSIBLE CEILING			RING, 1" CONDUIT TO ACCESSIBLE CEILING		COND./C	CONDUIT	РВ	PUSHBUTTON		
DES,	ΦE	DIRECTIONAL LIGHT, LETTER IDICATES FIXTURE TYPE, REFER TO FIXTURE SCHEDULE			SYM DESCRIPTION COLOR STANDARD 20A IVORY/WHITE					b	STROBE, NUMBER DENOTES 'cd' RATING, PROVIDE 4" SQ. DEEP J-BOX WITH SINGLE		CKT	CIRCUIT	PC	PHOTOCELL	EQUIPMENT SUPPLIER	MEANS A PERSON WHO GENERATE, SUPPLIES AND SELLS SPECIAL EQUIPMENT FOR USE IN THE PROJECT.
					IG ISOLATED GROUND ORANGE W/ TRIANGLE		I	DATA BOX IN WALL, 4" SQ. DEEP J-BOX WITH 18" SINGLE GANG PLASTER RING, STUB UP 1"		45	GANG PLASTER RING, 1" CONDUIT TO		CLG	CEILING	PH	PHASE		·
THE	ЕОН	WALL MOUNTED FIXTURE, CAPITAL LETTER INDICATES FIXTURE TYPE, REFER TO FIXTURE			GFI 20A GFI RATED IVORY/WHITE UPS 15A OR 20A FOR GRAY		•	WITH PULLSTRING TO ABOVE ACCESSIBLE			ACCESSIBLE CEILING		CONN	CONNECTION	PNL	PANEL	PROVIDE	FURNISH AND INSTALL, UNLESS OTHERWISE NOTED.
		SCHEDULE			D DEDICATED 5-20R GRAY			CEILING			PROVIDE 4" SQ. DEEP J-BOX WITH SINGLE GANG PLASTER RING, 1" CONDUIT TO 96"		CU	CUPPED	PRV	PANEL POWER ROOF VENTILATION	OR EQUAL	EQUAL IN QUALITY AND FUNCTION.
ALL	E O	RECESSED CAN FIXTURE, CAPITAL LETTER INDICATES FIXTURE TYPE, REFER TO FIXTURE			EM EMERGENCY RED C CHILD PROOF IVORY/WHITE		1	TEL. BOX IN WALL, 4" SQ. DEEP J-BOX WITH 18"			ACCESSIBLE CEILING RATING, PROVIDE 4" SQ.		DISC	DISCONNECT	PVC	PLASTIC CONDUIT	INSTALL	FURNISH AND INSTALL, UNLESS OTHERWISE NOTED.
EN		SCHEDULE			DUPLEX RECEPTACLE OUTLET GFI RATED,		K	SINGLE GANG PLASTER RING, STUB UP 1" WITH PULLSTRING TO ABOVE ACCESSIBLE			DEEP J-BOX WITH SINGLE GANG PLASTER RING. 1" CONDUIT TO ACCESSIBLE CEILING		EC	ELECTRICAL CONTRACTOR	RECEP	RECEPTACLE		,
	⟨ / ⟩EF−1	EXHAUST FAN, REFER TO MECHANICAL PLANS		=	WALL MOUNTED	44		CEILING			,		EM	EMERGENCY	RTU	ROOF TOP UNIT		
OR	√_\r_i − i			€	120/250VAC - 30A. 10-30R, RECEPTACLE	18"	В	CHIME FOR DOOR BELL, WALL MOUNTED	3)	SMOKE DETECTOR		EPEC	EL PASO ELECTRIC COMPANY	SW	SWITCH		
7	-	POLE LIGHTING FIXTURE, CAPITAL LETTER INDICATES FIXTURE TYPE, REFER TO FIXTURE		J	WALL MOUNTED SWITCHED OUTLET, SPLIT WIRE	40"	T	TRANSFORMER. VERIFY WITH MANF.)	CARBON MONOXIDE/SMOKE DETECTOR	- E	EQUIP	EQUIPMENTS	TC	TIMER CONTACTOR		
ATED.	<u> </u>	SCHEDULE		\ominus	1/2 SWITCHED, 1/2 HOT	18"		THERMOSTAT, BY OTHERS, PROVIDE 4" SQ.)	DUCT DETECTOR	E	EWC	ELECTRICAL WATER COOLER	TEL	TELEPHONE		
	P2 ● ●	DECORATIVE POLE LIGHTING FIXTURE, CAPITAL		+	QUADRUPLEX RECEPTACLE, WALL MOUNTED	18"		DEEP J-BOX WITH SINGLE GANG PLASTER 48"	FA		FIRE ALARM CONTROL PANEL WITH	E	EWH	ELECTRICAL WATER HEATER	T OR TRAN	TRANSFORMER		
	Ψ	LETTER INDICATES FIXTURE TYPE, REFER TO FIXTURE SCHEDULE		··	FLOOR BOX WITH DUPLEX RECEPTACLE			RING			DIGITAL NOTIFIER	F	FA	FIRE ALARM	TYP	TYPICAL		
	Д	BOLLARD LIGHTING FIXTURE, CAPITAL LETTER			AND SINGLE GANG TEL/DATA		S	HVAC CONTROLS, BY OTHERS, PROVIDE 4" SQ. DEEP J-BOX WITH SINGLE GANG PLASTER 48"	FA	RA	FIRE ALARM REMOTE ENUNCIATOR	F	FLA	FULL LOAD AMPERES	UG	UNDER GROUND		
L	Φ{N}	INDICATES FIXTURE TYPE, REFER TO FIXTURE SCHEDULE			FLOOR BOX WITH QUADRUPLEX RECEPTACLE			RING, 1" CONDUIT TO ACCESSIBLE CEILING		P	FIRE ALARM KEY PAD	l f	FLOUR	FLUORESCENT	UH	UNIT HEATER		
ND	0 0	CEILING FAN WITH OR WITHOUT LIGHTING KIT,		$ $ $ $ $ $ $ $ $ $	AND SINGLE GANG TEL/DATA							 	F	FUSE	UV	UNIT VENTILATOR		
	=	CAPITAL LETTER INDICATES FIXTURE TYPE,		\bigcirc	DUPLEX RECEPTACLE OUTLET, CEILING		⋈ TV	DATA/TEL. BOX IN WALL, 4" SQ. DEEP J-BOX WITH SINGLE GANG PLASTER RING. STUB UP					GC	GENERAL CONTRACTOR	V	VOLT		
EACH	0 0	REFER TO FIXTURE SCHEDULE			MOUNTED			1" WITH PULLSTRING TO ABOVE ACCESSIBLE					GFI	GROUND FAULT INTERRUPTER	VA	VOLT AMPERES		
THE	△ EM	EMERGENCY LIGHT, CAPITAL LETTER INDICATES FIXTURE TYPE, REFER TO FIXTURE		\Rightarrow	DUPLEX RECEPTACLE OUTLET, STUBB-UP 18" AFF FOR EQUIPMENT			CEILING					GND	GROUND	W	WATTS		
		SCHEDULE			ELECTRICAL WIRING THRU WALL OR CEILING		В	BUZZER, CEILING MOUNTED OR WALL						GALVANIZED RIGID STEEL	WP	WEATHER PROOF		
IS		EXIT LIGHT, CAPITAL LETTER INDICATES			ELECTRICAL WIRING THRO WALL OR GLILING		_	MOUNTED, PROVIDE 4" SQ. DEEP J-BOX WITH SINGLE GANG PLASTER RING					GRS HP	HORSE POWER	w/0	WITHOUT		
ES,	⊗ X1	FIXTURE TYPE, REFER TO FIXTURE SCHEDULE			ELECTRICAL WIRING BELOW FLOOR OR GRADE			PUSH BUTTON FOR BUZZER, CEILING				'	H7	HERTZ	WTR	WATER		
7	\$	WALL SWITCH, 20A SINGLE POLE, SINGLE	48"	– –E _{UG} —	ELECTRICAL FEEDER, UNDER GRADE		Р	MOUNTED OR WALL MOUNTED, PROVIDE 4"					IG	ISOLATED GROUND	Υ	WYE CONNECTED		
	,	TROW			·			SQ. DEEP J-BOX WITH SINGLE GANG PLASTER RING					J-BOX	JUNCTION BOX	Ø	PHASE		
ALS		SYM DESCRIPTION SYM DESCRIPTION		—т—	TELEPHONE CONDUIT WITH PULLSTRING			PUSH BUTTON FOR DOOR OPENER, CEILING					KV	KILOVOLT				
ESS		ab SWITCH LEG CONTROL P RED PILOT LIGHT 2 DOUBLE POLE T ROTARY TIMER		•	RACEWAY/WIREWAY ASSEMBLY DOWN		PB	MOUNTED OR WALL MOUNTED, PROVIDE 4" SQ. DEEP J-BOX WITH SINGLE GANG PLASTER					KVA	KILOVOLT AMPERES				
		3 THREE WAY 4 FOUR WAY HORSE POWER MOTOR RATED SWITCH			RACEWAY/WIREWAY ASSEMBLY UP			RING					KW	KILOWATT				
D OR		D SLIDER DIMMER (1400W MIN.) OR OCCUPANCY SENSOR, WITH BYPASSINFRA-			STUBBED CONDUIT, TERMINATE WITH ISOLATED PLASTIC BUSHING			3/4" FIRE RATED PLYWOOD WITH #6 CU.					LTG	LIGHTING				
OR		K KEYED SWITCH (WITH RED SENSOR OPERATING DEVICE			HOME RUN TO PANELBOARD, CROSS MARKS			GROUND TO BUILDING GROUNDING SYSTEM						MECHANICAL CONTRACTOR				
		TOOL) OU OCCUPANCY SENSOR, WITH BYPASS		. A−X	INDICATE QUANTITY OF WIRE, ARROWS								MCM	THOUSAND CIRCULAR MIL				
LL.		B BYPASS SWITCH ULTRASONIC SENSOR LV LOW VOLTAGE SWITCH OC OCCUPANCY SENSOR		 ►	INDICATE QUANTITY OF CIRCUITS, NUMBERS INDICATE PANEL AND CIRCUITS								MTD	MOUNTED				
HAT		WITH BYPASS			HOME RUN TO PANELBOARD, CROSS MARKS								NC	NORMALLY CLOSED				
) A		DUAL TECHNOLOGY	-		INDICATE QUANTITY OF WIRES. ARROWS								110	NOTION DECOLE				
SE		CEILING MOUNTED OCCUPANCY SENSOR, WITH		- -A-X	INDICATE QUANTITY OF CIRCUITS, SOLID CIRCUIT INDICATED GROUND. OPEN CIRCLE													
	₩ oc	BYPASS SWITCH WALL MOUNTED	_		INDICATE ISOLATED GROUND, NUMBERS													
		SYM DESCRIPTION	+		INDICATE PANEL AND CIRCUITS													
DE A		OR OCCUPANCY SENSOR, WITH BYPASS INFRA-RED SENSOR		— Î ≠ A−X	HOME RUN TO PANELBOARD, CROSS MARK ON ARROW INDICATE CIRCUIT CONTINUES TO													
		OU OCCUPANCY SENSOR, WITH BYPASS		111 '	OTHER DEVICE.													
ALL		ULTRASONIC SENSOR		, I P	HOME RUN TO PANELBOARD, CROSS MARK													
S OF		OCCUPANCY SENSOR, WITH BYPASS		Щ	INDICATE CIRCUIT CONTINUES TO OTHER DEVICE.													
		OC DUAL TECHNOLOGY SENSOR (INFRARED & ULTRASONIC)		3.6	HOME RUN, CROSS MARK INDICATE CIRCUIT,													
LIC IN		,		I	HALF CIRCUICLE INDICATE SWITCH LEGS													

ELECTRICAL GENERAL NOTES

EXCESSIVE VOLTAGE DROP AS FOLLOWS: 60' TO 100' - #10 AWG; OVER A. THE ELECTRICAL CONTRACTOR SHALL FAMILIARIZE THEMSELVES WITH THE K. INSTALL BLANK DEVICE PLATES ON ALL UNUSED JUNCTION BOXES IN PROJECT CONDITIONS.

- ARCHITECTURAL AND MECHANICAL EQUIPMENT AND PROVIDE ELECTRICAL CONNECTIONS IN THIS CONTRACT FOR ANY ITEM REQUIRED.
- C. THE CONTRACTOR SHALL FAMILIARIZE THEMSELVES WITH PROJECT PRIOR M. REFER TO POWER PLANS FOR DETAILED LAYOUTS OF ELECTRICAL GEAR. TO THE BID OPENING, TO ALLOW HIM TO SUBMIT A COMPLETE BID WITHIN THE SCOPE OF THE DRAWINGS AND SPECIFICATIONS. ANY QUESTIONS ARISING DURING THE BID PERIOD, IN REGARD TO THE CONTRACTOR'S FUNCTIONS, THE SCOPE OF THE WORK OR ANY OTHER ISSUE RELATED TO THIS PROJECT SHALL BE BROUGHT UP DURING THE BID PERIOD WITH THE ENGINEER FOR CLARIFICATION PRIOR TO AWARD OF CONTRACT.
- D. IT WILL BE THE CONTRACTOR'S OBLIGATION TO INCLUDE, IN THEIR BID, THE COSTS FOR INSTALLING JUNCTION BOXES, PROVIDING MISCELLANEOUS COVERS, WORK WITH OTHER DISCIPLINES WHERE THE CONTRACT INVOLVES ELECTRICAL POWER OR CONTROL CONNECTIONS, SWITCHES, ETC. ALL OF THIS WORK SHALL BE PART OF THIS CONTRACT.
- E. LOCATION OF EQUIPMENT AND OTHER DEVICES SHOWN ON THE PLANS ARE APPROXIMATE AND SHALL BE FIELD VERIFIED, COORDINATE WITH ARCHITECTURAL DOCUMENTS FOR EXACT LOCATIONS.
- F. THE CONDUIT RUNS AS SHOWN ON PLANS INDICATE APPROXIMATE ROUTING. EXACT LOCATION OF CONDUIT RUNS SHALL BE AS FIELD CONDITIONS DICTATE.
- 16. ENCLOSURES, BOXES AND COVERS ARE REQUIRED TO CONFORM TO ALL G. CONTRACTOR SHALL INSTALL PULL AND JUNCTION BOXES WHEREVER REQUIRED BY N.E.C. OR JOB CONDITIONS. ALL NEW WIRING SHALL BE TAGGED AT ALL PULL BOXES, JUNCTION BOXES, EQUIPMENT BOXES AND CABINETS WITH APPROVED PLASTIC TAGS. ACTION CRAFT, BRADY OR APPROVED EQUAL.
 - H. SHOULD CONTRACTOR AT ANY TIME NOTICE THAT THE ACTUAL FIELD CONDITIONS DO NOT CORRESPOND TO THE INFORMATION GIVEN ON THE DRAWINGS, THEN IT WILL BE THEIR RESPONSIBILITY TO NOTIFY THE ENGINEER FOR CLARIFICATION, PRIOR TO COMMENCING SUCH WORK.
 - I. IT SHALL BE THE RESPONSIBILITY OF THE CONTRACTOR TO COORDINATE WITH ALL TRADES FOR THE EXACT LOCATION OF EQUIPMENT AND APPURTENANCES THAT REQUIRE ELECTRICAL CONNECTIONS.
 - J. CONTRACTOR SHALL MAKE AS-BUILT DRAWINGS DOCUMENTING ANY AND ALL WIRING AND EQUIPMENT CONDITIONS AND CHANGES WHILE COMPLETING THIS CONTRACT. PROVIDE UPDATED TYPEWRITTEN DIRECTORIES FOR ALL PANELS AND LABEL ALL PANELS WITH PLASTIC LAMINATED NAMEPLATES.

- FINISHED AREAS.
- B. THE ELECTRICAL CONTRACTOR SHALL FAMILIARIZE THEMSELVES WITH ALL L. ALL ELECTRICAL WIRING AND HOME RUN CIRCUITING TO PANELS SHALL BE ROUTED IN CONDUIT, MIN SIZE 3/4" EMT CONDUIT IF NOT NOTED ON DRAWINGS.

PANELBOARD, REFER TO CORRESPONDING

PANEL SCHEDULE

- N. AFTER THE CONTRACTOR HAS RECEIVED APPROVED SHOP DRAWINGS FOR THE ELECTRICAL DISTRIBUTION EQUIPMENT, THEY SHALL SUBMIT SCALED LAYOUTS OF ALL ELECTRICAL EQUIPMENT TO THE ENGINEER FOR APPROVAL TO ENSURE THAT ALL CLEARANCE REQUIREMENTS ARE MET. THIS SUBMITTAL SHALL BE PROVIDED WITH SUFFICIENT TIME SO AS NOT INTERFERE WITH THE TIMELY EXECUTION OF THE ROUGH-IN WORK THAT WILL BE REQUIRED.
- O. WHEREVER REQUIRED, FURNISH AND INSTALL ON WALL OR CEILING FREESTANDING UNISTRUT CHANNELS, ANGLE IRONS OR ANY OTHER SUPPORT STRUCTURE WITH THREADED ROD HANGERS AS REQUIRED FOR THE SUPPORT OF ELECTRICAL EQUIPMENT OF ANY KIND TO ENSURE PROPER INSTALLATION.
- P. ALL NEW WIRING SHALL BE COPPER, MIN #12 THWN CU.
- Q. MOUNTING HEIGHTS INDICATED ON THE DRAWINGS ARE APPROXIMATE THIS CONTRACTOR SHALL BE RESPONSIBLE FOR COORDINATING WITH OTHER TRADES FOR EXACT HEIGHT REQUIRED. THIS REQUIREMENT ALSO APPLIES TO THE LOCATION OF WALL BOXES FOR HVAC SENSORS, T-STATS, ETC. ANY THIS NOTE APPLIES TO ALL ELECTRICAL SHEETS IN THESE DRAWINGS: OUTLET DEVICES THAT HAVE TO BE RELOCATED DUE TO COUNTERTOP, CHALKBOARD, TACKBOARD, TYPE CONFLICTS WILL BE DONE AT NO ADDITIONAL COST TO THE OWNER.
- R. ELECTRICIAN TO CONFIRM POWER REQUIREMENTS FOR MECHANICAL EQUIPMENT DELIVERED ON SITE.
- S. ALL EXPOSED CONDUIT SHALL BE PAINTED TO MATCH ARCHITECTURAL WALL OR CEILING.
- T. CONTRACTOR SHALL SAW CUT AND PATCH ASPHALT, CONCRETE OR OTHER MATERIAL ENCOUNTERED AS REQUIRED TO INSTALL NEW UNDERGROUND RACEWAY. REFER TO ARCHITECTURAL REGARDING PATCHING REQUIREMENTS.
- U. CONTRACTOR SHALL COORDINATE INSTALLATION OF NEW LAY-IN FIXTURES WITH ARCHITECTURAL REFLECTED CEILING PLAN AND MECHANICAL DIFFUSERS PRIOR TO INSTALLATION OF FIXTURES.

V. PROVIDE BLANK METAL COVERPLATE OVER ALL UNUSED OUTLET BOXES. PAINT COVERPLATE TO MATCH ADJACENT SURFACES.

ELECTRICAL SYMBOL LEGEND

- W. OUTLET MOUNTING HEIGHTS INDICATED ON THE DRAWINGS ARE APPROXIMATE. THIS CONTRACTOR SHALL BE RESPONSIBLE FOR COORDINATING WITH OTHER TRADES FOR EXACT HEIGHT REQUIRED. THIS REQUIREMENT ALSO APPLIES TO SWITCHES, TELEPHONE OUTLETS, DATA OUTLETS, HVAC SENSORS, ETC.. ANY DEVICE THAT HAS TO BE RELOCATED DUE TO CONTRACTOR'S FAILURE TO COORDINATE LOCATION WITH COUNTERTOPS, CHALKBOARDS, TACKBOARDS, ETC. WILL BE DONE AT NO ADDITIONAL COST TO THE OWNER.
- X. ALL RECEPTACLES TO BE 20A COMMERCIAL GRADE, IVORY OR AS SELECTED BY OWNER. WALL PLATES TO MATCH. ISOLATED GROUND DUPLEX RECEPTACLES (IG) WILL BE ORANGE BODY AND FACE PLATE.
- Y. INSTALL WALL MOUNTED LIGHT FIXTURES, SWITCHES, OUTLETS, AND COMMUNICATION DEVICES IN STRICT COORDINATION WITH ARCHITECTURAL DETAILS, SECTIONS AND ELEVATIONS.
- Z. FIRESTOPPING OF PENETRATIONS IN FIRE-RATED WALLS, FLOORS, etc. SHALL BE DONE BY A FIRESTOPPING CONTRACTOR. ELECTRICAL CONTRACTOR SHALL MAKE REQUIRED PENETRATIONS IN RATED WALLS, FLOORS, etc. NEATLY AND WITH A CUTTING TOOL, THE CONTRACTOR SHALL MAKE THE PENETRATIONS NO LARGER THAN NECESSARY, AND THE CONTRACTOR SHALL COORDINATE ALL SUCH PENETRATIONS WITH THE FIRE STOPPING CONTRACTOR BEFORE SUCH PENETRATIONS ARE MADE.
- AA. PROVIDE 1" CONDUIT. WITH PULLSTRING FROM COMMUNICATION OUTLETS
- BB. SUPPORT ALL FIXTURES FROM STRUCTURE ABOVE. CEILING TILES OR PLASTER CEILING SHALL NOT SUPPORT FIXTURES.


TO ABOVE SUSPENDED CEILING.

- CC. FINISHED FLOOR ELEVATIONS FOR OUTLETS AND OTHER DEVICES ARE TO CENTER OF BOX. WHERE MILLWORK IS PRESENT, BOTTOM OF BOX SHALL BE MINIMUM OF 2" ABOVE BACK- SPLASH, REGARDLESS OF DIMENSION SHOWN ON PLANS.
- DD. SUPPORT HORIZONTAL RUNS OF EMT CONDUIT EVERY 10'-0" AND AT EVERY FITTING, BOX, PANEL, etc..
- EE. USE GLAND RING COMPRESSION THREADED FITTINGS WITH INSULATED THROAT FOR EMT CONDUIT. DOUBLE SET SCREW FITTINGS ARE ACCEPTABLE FOR 2-1/2" CONDUIT AND LARGER ONLY.
- FF. ELECTRICAL CONTRACTOR SHALL COORDINATE WITH MECHANICAL CONTRACTOR THE MECHANICAL EQUIPMENT'S ELECTRICAL REQUIREMENTS. INCLUDING POWER, CONTROL, COMMUNICATION, AND MONITORING, OF EACH DEVICE PROVIDED AND/OR INSTALLED BY MECHANICAL CONTRACTOR.

GG. BEFORE INSTALLATION, EQUIPMENT AND DEVICES INCLUDING, BUT NOT LIMITED TO, ANY DEVICE WITH ELECTRICAL CONNECTIONS, DUCTWORK INSULATION, PIPING, VALVES, AIR DEVICES, ETC., SHALL NOT BE STORED DIRECTLY ON GRADE OR ON A SLAB OR FLOOR. BEFORE AND AFTER INSTALLATION, SUCH EQUIPMENT AND DEVICES SHALL BE PROTECTED FROM ENTRY OF DIRT, TRASH, WATER (EXCEPT AS REQ'D), VERMIN, ETC..

DEFENITIONS

- HH. DEVICES THAT MIGHT CAUSE OR OPERATE WITH VIBRATION OR NOISE SHALL BE ISOLATED PER MANUFACTURER'S RECOMMENDATIONS.
- II. ALL CONDUIT INSTALLED ON THE ROOF MUST BE SUPPORTED, WITH CONDUIT SUPPORTS EVERY 10'-0". CONDUIT SUPPORT TO BE DURA-BLOCK, CONTRACTOR TO PROVIDED SIZED AND ACCESSORIES REQUIRED.
- JJ. ALL GFCI RATED RECEPTACLE SHALL BE INSTALLED IN AN ACCESSIBLE SERVICE LOCATION, IT SHALL NOT BE INSTALLED BEHIND ANY EQUIPMENT. IF NEEDED CONTRACTOR SHALL HAVE THE OPTION TO PROVIDE A GFCI RATED CIRCUIT BREAKER WHERE REQUIRED BY CODE. ALL EQUIPMENT GFCI RATED RECEPTACLES SHALL NOT BE INSTALLED MORE THAN 12"FROM SERVING EQUIPMENT. COORDINATE ALL LOCATIONS WITH EQUIPMENT INSTALLER BEFORE DOING ANY WORK.
- KK. CONTRACTOR MUST PROVIDE DUCT SMOKE DETECTORS IN HVAC UNITS 2,000 CFM AND ABOVE. PROVIDE REMOTE TEST SWITCH AND MAKE CONNECTIONS AS REQUIRED.
- LL. FINAL ELECTRIC SERVICE IS BASED ON CONNECTED LOAD CALCULATIONS. CONTRACTOR SHALL COORDINATE WITH LOCAL ELECTRIC COMPANY FOR ANY REQUIREMENTS PRIOR TO PROJECT STARTUP. CONTRACTOR IS RESPONSIBLE FOR FOLLOWING LOCAL ELECTRIC COMPANY STANDAR5RDS, (EPEC BLUE BOOK), FOR SERVICE INSTALLATION.
- MM. ALL ELECTRICAL JUNCTION BOXES SIMILAR ELECTRICAL EQUIPMENT MUST BE PLACED IN A MANNER THAT PROVIDE COMPLETE SERVICEABILITY FOR THE JUNCTION BOX AND / OR EQUIPMENT AS WELL AS ANY OTHER ADJACENT MEP EQUIPMENT. ANY CONFLICTS THAT ARISE FROM IMPROPER PLACEMENT ARE TO BE CORRECTED IMMEDIATELY AT NO ADDITIONAL COST TO THE OWNER.
- NN. PER NFPA 25- STANDARD FOR THE INSPECTION, TESTING AND MAINTENANCE OF WATER-BASED FIRE PROTECTION SYSTEMS PARAGRAPH 5.2.2.2 "SPRINKLER PIPING SHALL NOT BE SUBJECTED TO EXTERNAL LOADS BY MATERIAL EITHER RESTING ON THE PIPE OR HUNG FROM THE PIPE. SUCH EXTERNAL LOADS INCLUDE BUT IS NOT LIMITED TO CEILING SYSTEMS, CEILING SUPPORT SYSTEM, LOW VOLTAGE CABLES OF ANY KIND, ELECTRICAL CONDUIT AND WIRING SYSTEMS, PLUMBING PIPING SYSTEMS, HVAC SYSTEMS, INSULATION ON EITHER PLUMBING OR HVAC, STRUCTURAL SUPPORTS OR BRACING. ANY CONFLICTS THAT ARISE FROM IMPROPER PLACEMENT ARE TO BE CORRECTED IMMEDIATELY AT NO ADDITIONAL COST TO THE OWNER.

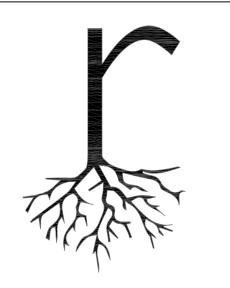

ARCHITECTS



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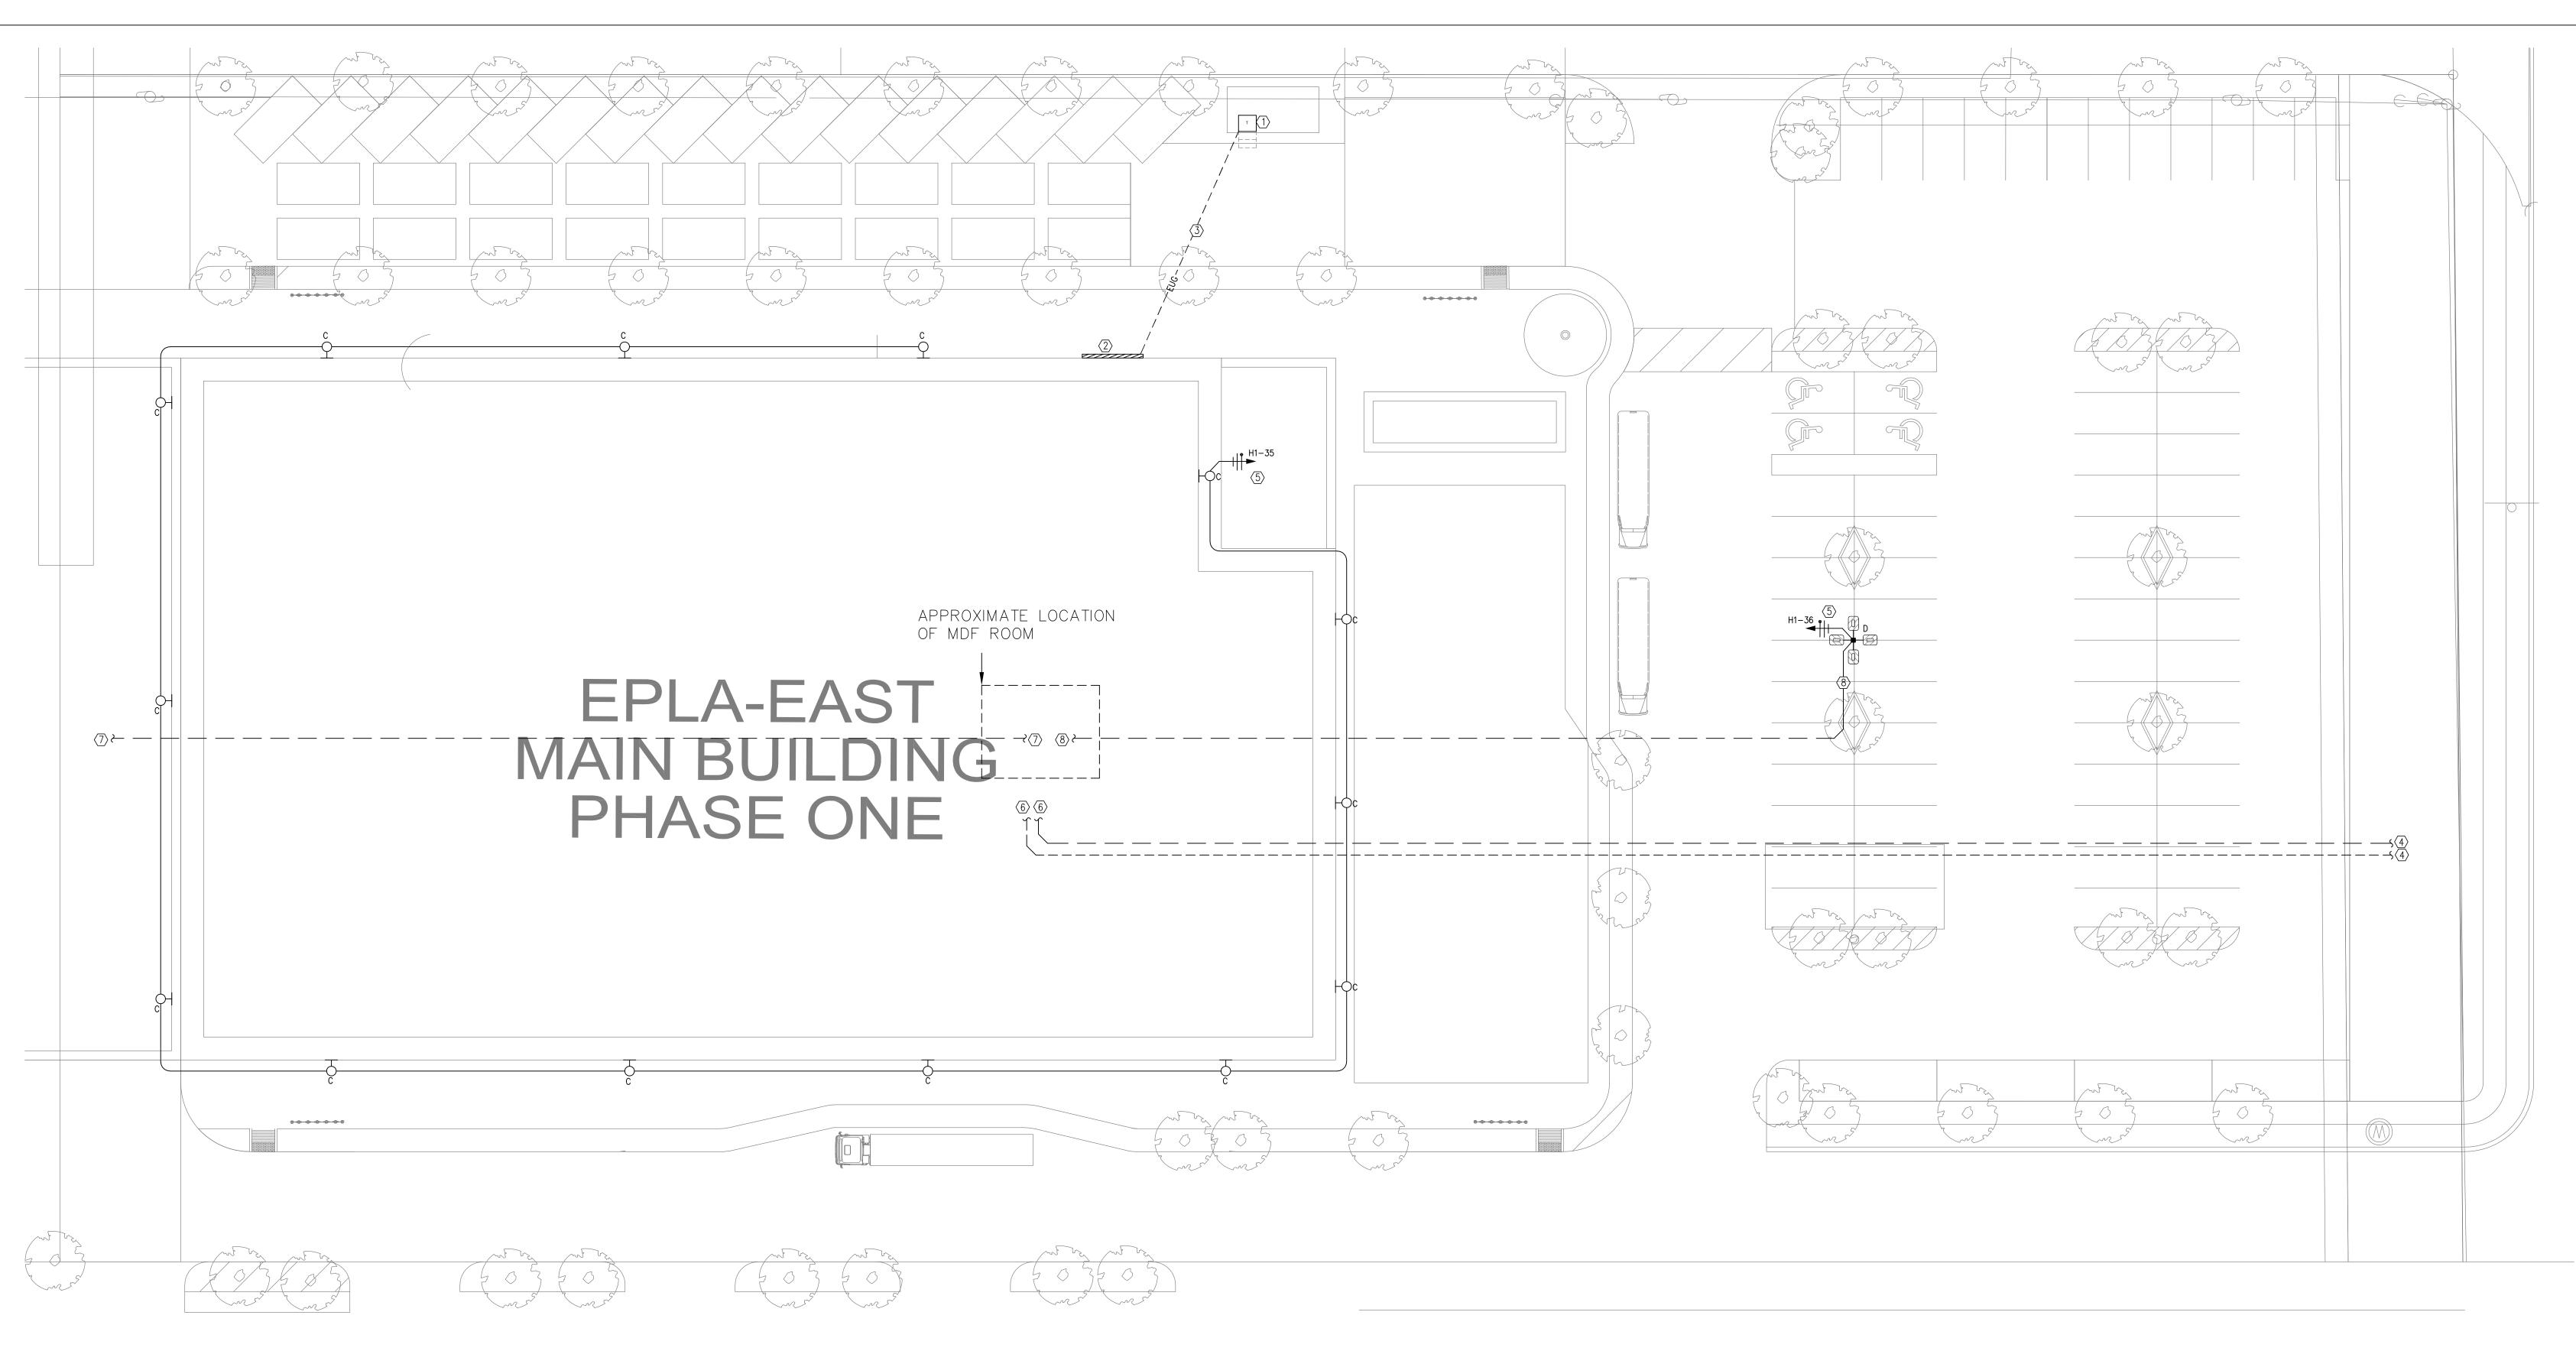
11.16.2020 REVISIONS

EL PASO TX, 79938

SHEET TITLE **ELECTRICAL**

GENERAL NOTES





1) ELECTRICAL SITE PLAN 1/16" = 1'-0"

ELECTRICAL SITE PLAN KEYED NOTES

- (1) LOCATION OF LOCAL ELECTRIC CO. TRANSFORMER, COORDINATE WITH LOCAL ELECTRIC CO. BEFORE DOING ANY WORK. FINAL LOCATION OF TRANSFORMER AND ELECTRIC METER TO BE DETERMINED BY LOCAL ELECTRIC CO.
- 2 LOCATION OF EPEC METER AND MAIN DISCONNECT, REFER TO ELECTRICAL RISER DIAGRAM 1/E500.
- \bigcirc (4) 3" CONDUITS EACH WITH 4-#350 MCM THWN CU. CONDUCTORS.
- 4" CONDUIT WITH PULLSTRING TO NEAREST TELEPHONE OR CABLE PULLBOX. COORDINATE WITH LOCAL UTILITY COMPANY BEFORE DOING ANY WORK.
- (5) THIS CIRCUIT TO BE WIRED THRU TIMER CONTACTOR, TIMER CONTACTOR TO BE CONTROLLED BY PHOTOCELL.
- (6) 4" CONDUIT WITH PULLSTRING TO 'MDF ROOM'.
- 7) 2" CONDUIT FROM 'MDF ROOM' BUILDING PERIMETER FROM PHASE II SITE. COORDINATE WITH OWNER FOR
- EXACT LOCATION OF CONDUIT SUBUP. 8) 2" CONDUIT FROM 'MDF ROOM' TO LIGHT POLE BASE.

COORDINATE WITH OWNER FOR EXACT REQUIREMENTS.

TOTAL OUTDOOR LIGHTING COMPLIANCE CALCULATION								
	LIGHTING	PROJECTED	ALLOWED	PERMITTED				
ZONING	ORDINANCE	AREA (ACRE)	LUMENS	TOTAL LUMENS				
	ZONE	(1 ACRE=43,560 SQ.FT.)	PER ACRE	(AREAXALLOWED LUMENS)				
C1	E4	3.18	1,000,000	3,181,772				

ITDOOR LUME					
SYMBOL	TYPE	LAMP	LUMENS	QUANTITY	TOTAL
		SOURCE	PER LAMP		LUMENS
TYPE 'C'	WALL	78 W LED	10,000	14	140,000
TYPE 'D'	POLE	229W MH	28,000	4	112,000
				TOTAL PROJECT LUMENS	252,000

	LIGHTIN	IG FIXTURE	SCHEDUL	E					
TYPE	MANUFACTURER/MODEL NO.			LED		COLOR	MOUNTING	NOTES	
TIPE	IVIANOPACTORERY IVIODEL INO.	SUPPLY	DIM	WATTS	TEMP.	COLOR	MOUNTING	INOTES	
B	LSI LCD6 LED 14L UNV DIM1 40 FL	277V		14W LED	40K	CBA	RECESSED		
В	METALUMEN #RM4D-1L35K-8-MD-L4 1 PAA 4	277V		100W LED	40K	WHT	PENDANT		
BE	METALUMEN #RM4D-1L35K-8-MD-L4 E PAA 4	277V		100W LED	40K	WHT	PENDANT		
B1	METALUMEN #RM4D-1L35K-4-MD-L4 1 PAA 4	277V		50W LED	40K	WHT	PENDANT		
B2	METALUMEN #RM4D-1L35K-C16-MD-L4 1 PAA 4	277V		200W LED	40K	WHT	PENDANT		
B2E	METALUMEN #RM4D-1L35K-C16-MD-L4 B PAA 4	277V		200W LED	40K	WHT	PENDANT		
SE	LSI W444 LED SS NW UE EM	277V		35W LED	40K	WHT	WALL		
С	LSI SMW-LED-10L-3-UNV-DIM-40	277V		78W LED			WALL		
В	LSI SMA-LED-28L-4-3 UNV-ACR-FT-40 4SQ50	277V		229W LED			50' POLE		
С	WILLIAMS 76R 4 L72 840 DIM UNV	277V		50W LED	40K	WHT	SURFACE		
G	FSW 2 30 830 UNV DIM	120V		29.9W LED			WALL		
X1	MULE LIGHTING MDC U R A A REM	120V		INCLUDED		WH	CEILING/WALL	[1]	
EL	MULE LIGHTING EM-80 W	120V		INCLUDED		WH	WALL	[1]	
EX	MULE LIGHTING RLED-2-WP	120V		INCLUDED		WH	WALL	[2]	
NOTES:	[1] PROVIDE WITH 90 MIN. MINIMUM POWER LIFE BAT	ΓERY							

[2] REMOTE MOUNTED EMERGENCY HEAD, CONNECT TO INTERIOR EXIT SIGN.

Medium Commerical Wall (SMW)

🚅 IP65 🚇 🚇 -



Optical System


Premium engineered IP65 rated polycarbonate optic assemblies deliver IES Type 3 or 4 (FT) distributions.

Zero Uplight.

Available in 5000K, 4000K & 5000K color temperatures per ANSI C78.377.

Minimum CRI of 70. Electrical
• 0-10V dimming (10% - 100%) standard. Standard Universal Voltage (120-277 Vac)
Input 50/60 Hz or optional High Voltage
(347-480 Vac)
 Standard Universal Voltage
(347-480 Vac)

 Compartment for installing/servicing.
 Back box accessory available for surface conduit and wiring.

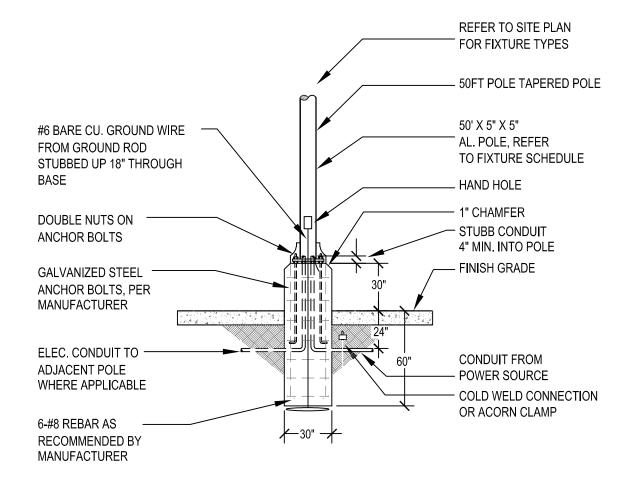

TYPICAL LIGHT POLE BASE DETAIL

GENERAL NOTES

- A. CONTRACTOR TO COORDINATE AND VERIFY WITH THE POLE LIGHTS VENDOR FOR FINAL INSTALLATION DETAIL AND PERFORM AS PER MANUFACTURER TO MEET WIND RATING.
- B. 18" DIA. ROUND HOLE MAY BE DRILLED FOR BASE, BUT TOP OF BASE SHALL BE SQUARED.


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SHEET TITLE

REVISIONS

ELECTRICAL SITE PLAN

ELECTRICAL | MECHANICAL | PLUMBING | FIRE SAFETY | ENERBY MANAGEMENT 1712 TEXAS | EL PASO | TEXAS | 79901 | 915.519.4340 | TFR: F-16001 WWW.RAXISENGINEERING.COM

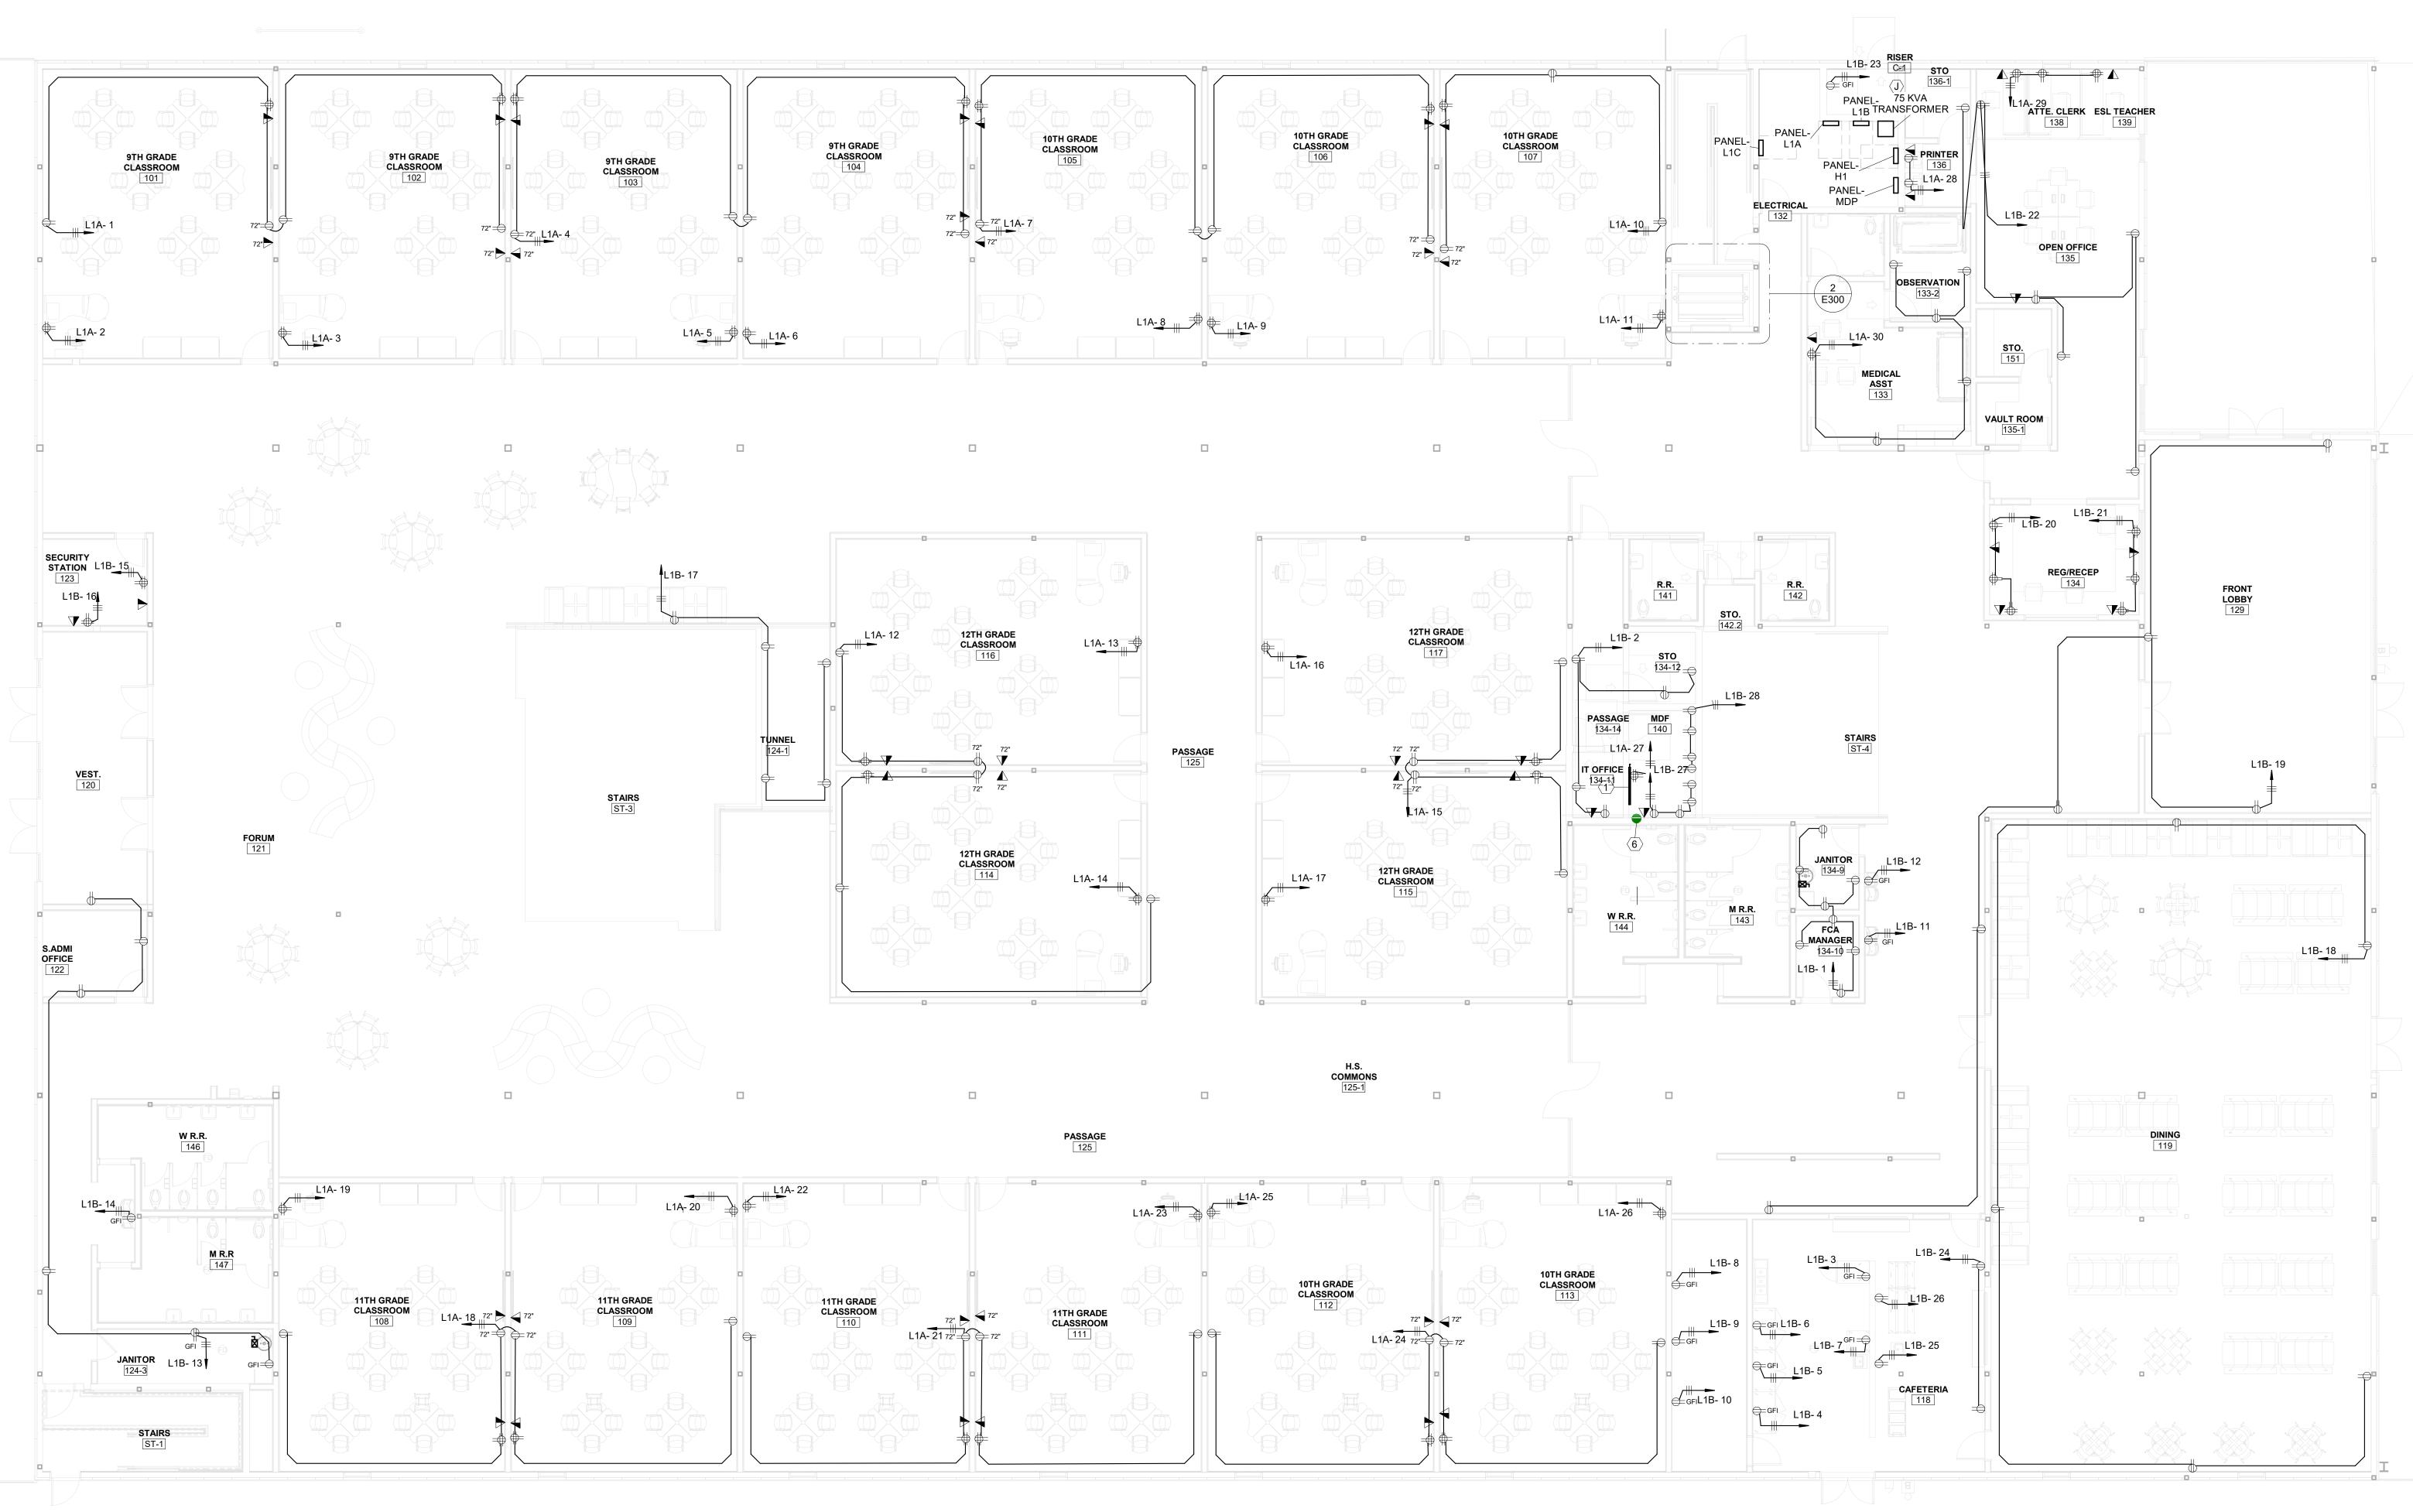

1 LEVEL 1 POWER PLAN 1/8" = 1'-0"


KEYED NOTES

- 1 INSTALL 4'X4'X5/8" FIRE TREATED PLYWOOD AND 4'
 ABOVE FINISH FLOOR. INSTALL GROUND BAR WITH #6 CU.
 GROUND TO BUILDING STEEL. COORDINATE WITH OWNER
 FOR EXACT LOCATION.
- 2 MAKE CONNECTIONS TO FIRE ALARM CONTROL PANEL. FIRE ALARM TO BE INSTALLED BY OTHERS.
- GFI RECEPTACLE FOR SUMP PUMP.


INSTALLER FOR REQUIREMENTS.

- 4 INSTALL TELEPHONE DATA BOX FOR DEDICATIED
 TIELEPHONE LINE, COORDINATIE WITH ELEVATOR
- 5 CIRCUIT BREAKER ENCLOSURE FOR ELEVATOR CAB LIGHTS.COORDINATIE WITH EQUIPMENT INSTALLER.
- 6 (2) 4" SLEEVES FROM MDF ROOM TO IDF ROOM ON SECOND FLOOR. COORDINATE WITH OWNER FOR EXACT
- REQUAIERMENTS AND LOCATION.

 PROVIDE AND INSTALL 60A, 3 POLE, 3PH CIRCUIT BREACKER WITH SHUNT TRIP. MAKE CONNECTIONS TO ELEVATOR SYSTEM AS REQUIRED. COORDINATE WITH EQUIPMENT INSTALLER FOR EXACT LOCATION AND POWER SUPPLY REQUIREMENTS.

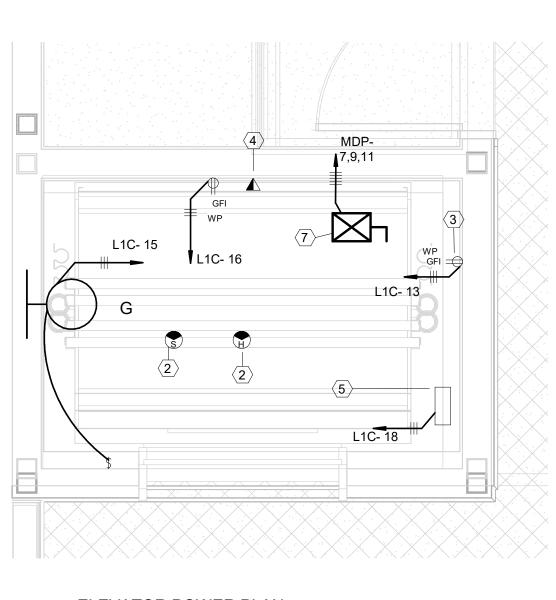

2 ELEVATOR POWER PLAN 1/2" = 1'-0"

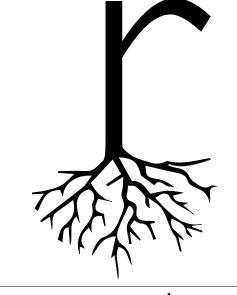

root



GENERAL NOTES

- A. ALL RECEPTACLES AND DATA LOCATIONS ARE TO BE VERIFIED BY OWNER PRIOR TO ROUGH-IN TO ENSURE FURNITURE LAYOUTS ARE COORDINATED.
- B. ALL RECEPTACLES SHALL BE TAMPER-RESISTANT AS PER NEC 2014 406.12(C).
- C. PROVIDE ALL CONDUIT ROUGH-IN FOR SPECIAL SYSTEMS.

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2101 JOE BATTLE BLVD EL PASO TX, 79938


DATE 12-21-20
REVISIONS

SHEET TITLE


POWER PLAN LEVEL 1

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E300

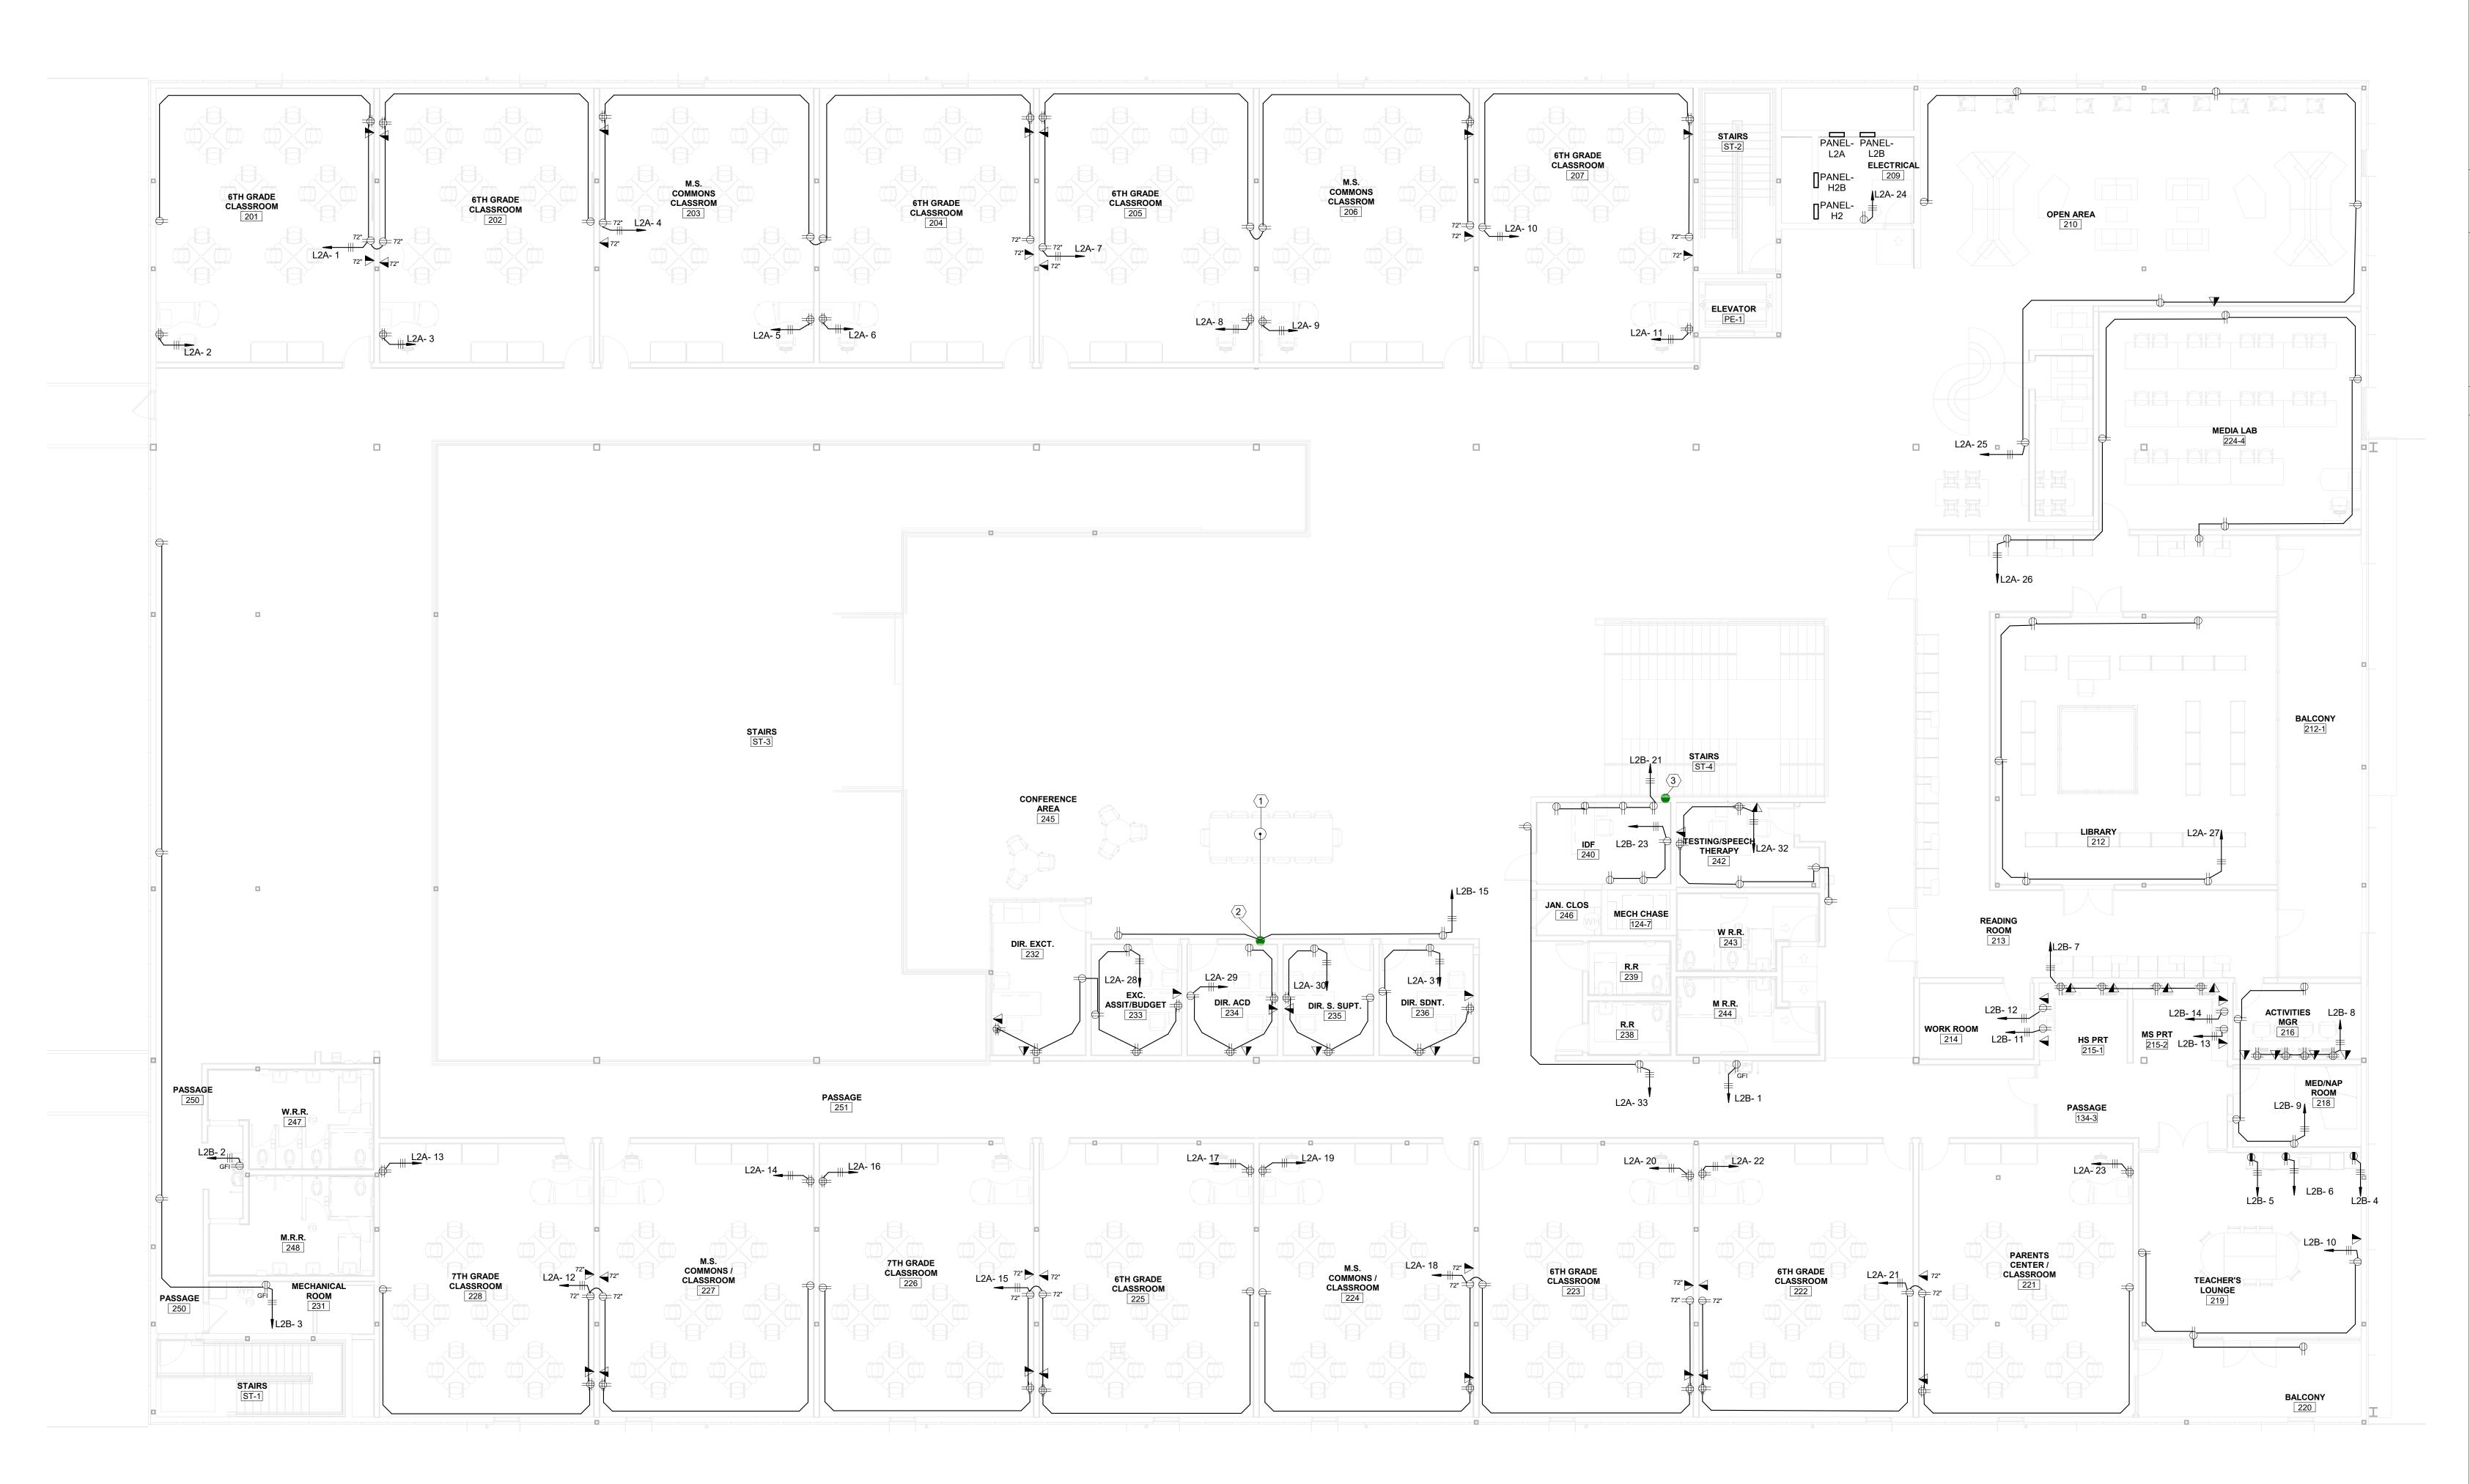

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GENERAL NOTES

- A. ALL RECEPTACLES AND DATA LOCATIONS ARE TO BE VERIFIED BY OWNER PRIOR TO ROUGH-IN TO ENSURE FURNITURE LAYOUTS ARE COORDINATED.
- B. ALL RECEPTACLES SHALL BE TAMPER-RESISTANT AS PER NEC 2014 406.12(C).
- C. PROVIDE ALL CONDUIT ROUGH-IN FOR SPECIAL SYSTEMS.
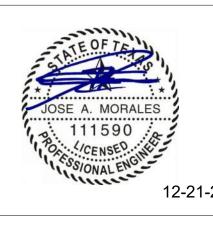
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2101 JOE BATTLE BLVD EL PASO TX, 79938

12-21-20 DATE **REVISIONS**

SHEET TITLE

POWER PLAN LEVEL 2

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1) LEVEL 2 POWER PLAN 1/8" = 1'-0"

KEYED NOTES

PROVIDE AND INSTALL POKE BOX WITH ONE QUAD RECEPTACLES AND SEPARATE SIDE FOR DATA OUTLETS. INSTALL FLUSH WITH FINISHED FLOOR AND PROVIDE BRASS COVER. FLOOR BOX TO BE LEGRAND WIREMOLD 6AT OR APPROVED EQUAL. COORDINATE WITH ARCHITECT FOR EXACT LOCATION PRIOR TO

COMMENCING ANY WORK. RISE TO ABOVE ACCESSIBLE CEILING WITH 2" CONDUIT WITH PULLSTRING.

(2) 4" SLEEVES FROM MDF ROOM TO IDF ROOM ON SECOND FLOOR. COORDINATE WITH OWNER FOR EXACT REQUAIERMENTS AND LOCATION.